CITY OF BLOOMINGTON, ENGINEERING DIVISION

CONSTRUCTION PLAN FOR 2013-304

BCS PHASE 2A INFRASTRUCTURE IMPROVEMENT PROJECT

STORM SEWER, SANITARY SEWER, WATERMAIN, GRADING, BASE, BITUMINOUS SURFACE, CURB AND GUTTER, SIDEWALK, AND LIGHTING

LOCATED ON: 33RD AVE. S. LOCATED ON: E. 81ST ST. FROM 14+00 TO 33RD AVE. S. FROM AMERICAN BLVD. TO LRT **LEGEND** CITY PROJ. NO. 2013-304 CITY PROJ. NO. 2013-304 **PROPOSED** GROSS LENGTH 486 FEET GROSS LENGTH CENTER LINE BRIDGES-LENGTH BRIDGES-LENGTH 0 FEET EXCEPTIONS-LENGTH 0 FFFT EXCEPTIONS-LENGTH 0 FEET RIGHT OF WAY LINE NET LENGTH 866 FEET PROPERTY LINE 486 FEET NET LENGTH PERM. EASEMENT LINE REF POINT STA. 14+00 TO POINT STA. 18+86 REF POINT STA. 5+18 TO POINT STA. 13+84 TEMP. EASEMENT LINE DESIGN DESIGNATION(ROADWAY)-TIER NO. N/A DESIGN DESIGNATION(ROADWAY)-TIER NO. N/A SECTION LINE No. of Traffic Lanes = 2 Parking Lanes = 0No. of Traffic Lanes = 2 Parking Lanes = EDGE OF ASPHALT ----- EOA --R-Value = 20R-Value = 20CURB & GUTTER LINE REMOVE CURB AND GUTTER Design Speed = 30 mph Ton Design = 9Design Speed = 30 mph Ton Design = 9 REM AND REPLACE C & G Functional Classification = LOCAL-URBAN Functional Classification = LOCAL-URBAN SEWER LINE Stopping Sight Distance Based On: Stopping Sight Distance Based On: SEWER SERVICE LINE 3.5 Feet Height Of Eyes 3.5 Feet Height Of Eyes STORM SEWER -->>-2 Feet Height Of Object 2 Feet Height Of Object WATER LINE — II — I — I — WATER SERVICE LINE WATER SRVC. LINE (ABAN.) ——CATV—— CATV LINE PROJECT LOCATION-COMMUNICATION ----- СОМ -----IRRIGATION - IRR -GAS LINE -049-OVERHEAD ELECTRIC -OF-FIBER OPTIC ---F0- Ξ UNDERGROUND ELECTRIC -ELEC-TELEPHONE CABLE UTILITY HANDHOLE 0 UTILITY POLE ക ά LIGHT POLE **AMERICAN** BLVD. UTILITY POLE W/ LIGHT ಭು GUY WIRE MANHOLE; STORM, SAN. 0 EAST 81ST STREET CATCH BASIN STA. 14+00 TO 18+86 HYDRANT CITY PROJECT NO. 2013-304 WATER VALVE WATER VALVE IN MANHOLE SQL шшшшшшш Ň RAILROAD CONIFEROUS TREE DECIDUOUS TREE CLEAR AND GRUB TREE × 82nd ST HEDGE PED. CURB RAMP \bigcirc TRAFFIC SIGNAL SIGN 8th SCALE IN FEET BLOCK RETAINING WALL 00000000 00000000 WOOD RETAINING WALL WOOD RETAINING WALL _____ **PLAN** TREE LINE 0 CHAIN LINK FENCE -0-0-0-0--0-0-0-0 **PROFILE** WOOD FENCE -0-0-0-0 MEADOW WIRE FENCE ---x--x--x--x-EROSION CONTROL FENCE \circ INLET PROTECTION (S) SANITARY MANHOLE 33RD AVENUE SOUTH STORM MANHOLE MH X STA. 5+18 TO 13+84 PROJECT LOCATION SOIL BORING CITY PROJECT NO. 2013-304 COUNTY: HENNEPIN CONCRETE WALK DISTRICT: METRO DIVISION REMOVE CONCRETE WALK PLAN REVISIONS BITUMINOUS SURFACE APPROVED BY REM. BITUMINOUS SURE. Kimley-Horn CONCRETE WALK SPECIAL and Associates, Inc. GRAVEL SURFACE

GOVERNING SPECIFICATIONS

THE 2014 EDITION OF THE MINNESOTA DEPARTMENT OF TRANSPORTATION "STANDARD SPECIFICATIONS FOR CONSTRUCTION".

ALL TRAFFIC CONTROL DEVICES SHALL CONFORM AND BE INSTALLED IN ACCORDANCE TO THE "MINNESOTA MANUAL ON UNIFORM TRAFFIC CONTROL DEVICES" (MN MUTCD) AND PART VI. "FIELD MANUAL FOR TEMPORARY TRAFFIC CONTROL ZONE LAYOUTS".

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Design Engineer: I hereby certify that this plan was prepared by me or under my direct supervision, and that I am a duly registered Professional Engineer under the laws of the State of Minnesota.

THIS PLAN CONTAINS 83 SHEETS

BY: Thomost Limb

Date: 06/10/2014

Registration Number: 21433

Approved: City Engineer

Date: 6/10/14

I HEREBY CERTIFY THAT THE FINAL FIELD REVISIONS, IF ANY, OF THIS PLAN WERE MADE BY ME OR UNDER MY DIRECT SUPERVISION AND THAT I AM A DULY REGISTERED PROFESSIONAL ENGINEER UNDER THE LAWS OF THE STATE OF MINNESOTA.

DATE _______ REG. NO._____

2550 UNIVERSITY AVE. WEST, SUITE 238N

ST. PAUL, MINNESOTA 55114

MILL BITUMINOUS SURFACE

SUBGRADE EXCAVATION

BUILDING

TEL. NO. (651) 645-4197 FAX. NO. (651) 645-5116

STATEMENT OF ESTIMATED QUANTITIES

	SEQ Created: 6/11/2014 @ 2:37:56 F	PM		TOTAL Q	UANTITY
ITEM NO.	ITEM DESCRIPTION	UNIT	NOTES	ESTIMATED QUANTITY	FINAL QUANTITY
2011.601	CONSTRUCTION SURVEYING	LUMP SUM		1	
2021.501	MOBILIZATION	LUMP SUM		1	
2101.502	CLEARING	TREE		3	
	GRUBBING	TREE		3	
2104.501	REMOVE SEWER PIPE (STORM)	LIN FT		59	
	REMOVE BITUMINOUS CURB	LIN FT		690	
	REMOVE CONCRETE CURB	LIN FT		1,500	
	REMOVE CONCRETE SIDEWALK REMOVE CONCRETE PAVEMENT	SQ FT SQ YD		3,115 75	
	REMOVE BITUMINOUS PAVEMENT	SQ YD		7,540	
	REMOVE CASTING	EACH		1	
2104.509	REMOVE DRAINAGE STRUCTURE	EACH		1	
	SAWING CONCRETE PAVEMENT (FULL DEPTH)	LIN FT		65	
	SAWING BIT PAVEMENT (FULL DEPTH)	LIN FT		1,405	
	SALVAGE LIGHT STANDARD AND LUMINARE SALVAGE SIGN TYPE C	EACH EACH		13 1	
	SALVAGE SIGN TYPE C SALVAGE ROADWAY SIGN	EACH		1	
	ADJUST PULL BOX	EACH		1	
	REMOVE ELECTRIC MANHOLE	EACH		1	
2405 = : :		0			
	COMMON EXCAVATION (P)	CU YD		4,800	
	SELECT GRANULAR BORROW (CV) (P) GEOTEXTILE FABRIC TYPE V	CU YD SQ YD		1,600 456	
	STRUCTURAL SOIL BORROW (CV) (P)	CU YD		654	
2123.610	STREET SWEEPER (WITH PICKUP BROOM)	HOUR		150	
2130.501	WATER	MGALLONS		20	
2211.503	AGGREGATE BASE (CV) CLASS 5 (P)	CU YD		2,000	
2204 602	DEDMANIENT TERMINAL LIFADERS	LINIET			
	PERMANENT TERMINAL HEADERS CONCRETE PAVEMENT SPECIAL - TYPE 3 STANDARD WIDTH 8'	LIN FT ' SQ YD		55 420	
2301.604	CONCRETE PAVEMENT SPECIAL - TYPE 4 STANDARD WIDTH 8			430	
2057 500	DITUMBLE MATERIAL FOR TACK COAT	0411011		500	
2357.502	BITUMINOUS MATERIAL FOR TACK COAT	GALLON		500	
	TYPE SP 12.5 WEARING COURSE MIX (4,B)	TON		950	
2360.502	TYPE SP 12.5 NON-WEARING COUSE MIX (4,B)	TON		890	
	12" RC PIPE SEWER DES 3006 CL V	LIN FT		70	
	15" RC PIPE SEWER DES 3006 CL V	LIN FT		327	
2503.541 2503.541	21" RC PIPE SEWER DES 3006 CL IV	LIN FT LIN FT		182 142	
	24" RC PIPE SEWER DES 3006 CL IV CONNECT TO EXISTING SANITARY SEWER	EACH		142	
	CONNECT TO EXISTING STORM SEWER	EACH		4	
	CONNECT INTO EXISTING DRAINAGE STRUCTURE	EACH		2	
	12" PVC PIPE SEWER SDR 35	LIN FT		140	
2503.603	15" PVC PIPE SEWER SDR 35	LIN FT		533	
2503.603	10" PVC PIPE SEWER SDR 35	LIN FT		340	
2504.601	IRRIGATION SYSTEM	LUMP SUM		1	
	IRRIGATION SYSTEM MODIFICATIONS	LUMP SUM		1	
2504.602	WATERMAIN OFFSET	EACH		1	
	CONNECT TO EXISTING WATERMAIN	EACH		2	
	INSTALL HYDRANT & VALVE	EACH		6	
	10" PIPE PLUG	EACH		2	
	12" PIPE PLUG 4" GATE VALVE AND BOX	EACH EACH		1 2	
	6" GATE VALVE AND BOX	EACH		1	
	8" GATE VALVE AND BOX	EACH		3	
2504.602	12" GATE VALVE AND BOX	EACH		8	
2504.602	WATER SERVICE METER MANHOLE	EACH		1	
2504.603	1-1/2" PVC IRRIGATION SLEEVING, SCH. 40	LIN FT		870	
	4" PVC IRRIGATION SLEEVING, SCH. 40	LIN FT		1,750	
	4" WATERMAIN DUCTILE IRON CL 52	LIN FT		35	
	6" WATERMAIN DUCTILE IRON CL 52	LIN FT		310	
	8" WATERMAIN DUCTILE IRON CL 52	LIN FT		110	
	12" WATERMAIN DUCTILE IRON CL 52	LIN FT		850	
	WATERMAIN ENCASEMENT	LIN FT		1,350	
2504.608 2504.608	WATERMAIN INSULATION WATERMAIN FITTINGS	SQ YD POUND		15 2,100	
-507.000	TOTAL CONTRACT OF THE CONTRACT	I COND		۷, ۱۰۰۰	

STATEMENT OF ESTIMATED QUANTITIES

BCS PHASE 2A INFRASTRUCTURE IMPROVEMENTS CITY PROJECT 2013-304

BLOOMINGTON STORE SHORTH ST.
BLOOMINGTON BROSSA
MINNESOTA PHONE (682) 563-8700

AM ASSOCIATES, INC.
STORE STORE STORE STORE
THE MINNESOTA STORE
THE MINNES

REVISIONS

DATE DESCRIPTION B'
TO 10/14

DATE ISSUED FOR BID To

IN CERTIFY THAT THIS PLAN WAS ED BY WE OR UNDER MY DIRECT ISION AND THAT I AM A DULY D PROFESSIONAL ENGINEER UNDER WS OF THE STATE OF MINNESOTA.

DRAWN: LMM CHECKED: BRE APPROVED: TJL

SHEET: 02 OF 83

STATEMENT OF ESTIMATED QUANTITIES


	SEQ Created: 6/11/2014 @ 2:37:56	PM		TOTAL Q	UANTITY
ITEM NO.	ITEM DESCRIPTION	UNIT	NOTES	ESTIMATED QUANTITY	FINAL QUANTITY
2506.501	CONST DRAINAGE STRUCTURE DESIGN 48-4020	LIN FT		55	
	CONST DRAINAGE STRUCTURE DESIGN 46-4020	LIN FT		12	
	CONST DRAINAGE STRUCTURE DESIGN 60-4020	LIN FT		15	
	CONST DRAINAGE STRUCTURE DESIGN 72-4020	LIN FT		15	
	CASTING ASSEMBLY (STORM)	EACH		14	
	CASTING ASSEMBLY (SANITARY)	EACH		7	
	ADJUST MANHOLE	EACH		1	
2506.603	CONSTRUCT SANITARY SEWER OUTSIDE DROP MANHOLE	LIN FT		17	
2506.603	CONSTRUCT SANITARY SEWER MANHOLE (48" DIA.)	LIN FT		112	
	4" CONCRETE WALK SPECIAL 1	SQ FT		500	
	4" CONCRETE WALK SPECIAL 2 5" CONCRETE WALK SPECIAL 3	SQ FT SQ FT		68 7,000	
	5" CONCRETE WALK SPECIAL 4	SQFT		3,275	
2321.010	O CONORE IE WALK SI ECIAE 4	3011		3,273	
2531.501	CONCRETE CURB & GUTTER DESIGN B618 SPECIAL 1	LIN FT		40	
	CONCRETE CURB & GUTTER DESIGN B612 SPECIAL 1	LINFT		241	
	CONCRETE CURB & GUTTER DESIGN B618 SPECIAL 4	LIN FT		350	
	CONCRETE CURB & GUTTER DESIGN D418 SPECIAL 4	LIN FT		710	
	8" CONCRETE VALLEY GUTTER SPECIAL 3	LIN FT		320	
	8" CONCRETE VALLEY GUTTER SPECIAL 4	LIN FT		590	
2531.618	TRUNCATED DOMES	SQ FT		72	
				_	
	BOLLARD	EACH		6	
2540.603	LANDSCAPE EDGER	LIN FT		330	
2545 500	CONDUIT SYSTEM A (LIGHTING)	LLINAD CLINA		4	
	CONDUIT SYSTEM B (LIGHTING)	LUMP SUM		1 1	
	CONDUIT SYSTEM C (POWER)	LUMP SUM		1	
	CONDUIT SYSTEM D (POWER)	LUMP SUM		1	
	LIGHTING UNIT TYPE SPECIAL SP1	EACH		1	
	LIGHTING UNIT TYPE SPECIAL SP4	EACH		3	
2545.511	LIGHTING UNIT TYPE SPECIAL SP6	EACH		25	
2545.511	LIGHTING UNIT TYPE SPECIAL SP8	EACH		6	
2545.515	LIGHT BASE DESIGN SPECIAL B	EACH		16	
	LIGHT BASE DESIGN SPECIAL A	EACH		18	
	SERVICE CABINET	EACH		1	
	EQUIPMENT PAD	EACH		1	
	HANDHOLE	EACH		25	
	ELECTRICAL SYSTEM MODIFICATIONS INSTALL SALVAGED LIGHT STANDARD AND LUMINARE	LUMP SUM EACH		1 13	
	LIGHT BASE COVER	EACH		34	
	GFCI RECEPTACLE	EACH		40	
2040.002	OF OFFICE TABLE	EAGIT		40	
2563.601	TRAFFIC CONTROL	LUMP SUM		1	
2564.531	SIGN PANELS TYPE C	SQ FT		79	
2564.537	INSTALL SIGN TYPE C	EACH		1	
2564.602	INSTALL ROADWAY SIGN	EACH		1	
	DECIDUOUS TREE 3" CAL B&B	TREE		41	
2571.507	PERENNIAL NO 3 CONT	PLANT		602	
0570 500	CHIT FENCE TYPE MACHINE CLICED	LINIET	ļ	0.000	
	SILT FENCE, TYPE MACHINE SLICED	LIN FT		2,200	
	STORM DRAIN INLET PROTECTION - TYPE 1	EACH		20 1	
	STORM DRAIN INLET PROTECTION - TYPE 2 SEDIMENT CONTROL LOG TYPE STRAW	EACH LIN FT		1 455	
	TEMPORARY ROCK CONSTRUCTION ENTRANCE	EACH		455 5	
20.0.002				Ŭ	
2574.525	COMMON TOPSOIL BORROW (CV) (P)	CU YD		240	
	(-,/,/,/	1		-	
2575.505	SODDING TYPE SALT TOLERANT	SQ YD		410	
2575.513	MULCH MATERIAL TYPE 6	CU YD		21	
	MULCH MATERIAL TYPE 9	CU YD		38	
2575.571	RAPID STABILIZATION METHOD 3	MGAL		10	
0500	DAYTHOO (DTARROW) FROM	1			
	PAVT MSSG (RT ARROW) EPOXY	EACH		2	
	PAVT MSSG (LT-THRU ARROW) EPOXY	EACH		2	
	4" SOLID LINE WHITE-PAINT 4" SOLID LINE WHITE-EPOXY	LIN FT LIN FT		1,000 160	
	4" DOUBLE SOLID LINE-YELLOW EPOXY	LIN FT		160	
	CROSSWALK MARKING - POLY PREFORM (GR IN)	SQ FT	-	192	
2002.000	IONOGOVANEN MANNING - I OLI I NEI ONM (ON IN)	JULTI		134	

BCS PHASE 2A INFRASTRUCTURE IMPROVEMENTS CITY PROJECT 2013-304 STATEMENT OF ESTIMATED QUANTITIES

BLOOMINGTON BLOOMINGTON MN 86431 PHONE (962) 863-6700 If and Associates, Inc.

REVISIONS
DESCRIPTION
ISSUED FOR BID

SHEET: 03 OF 83

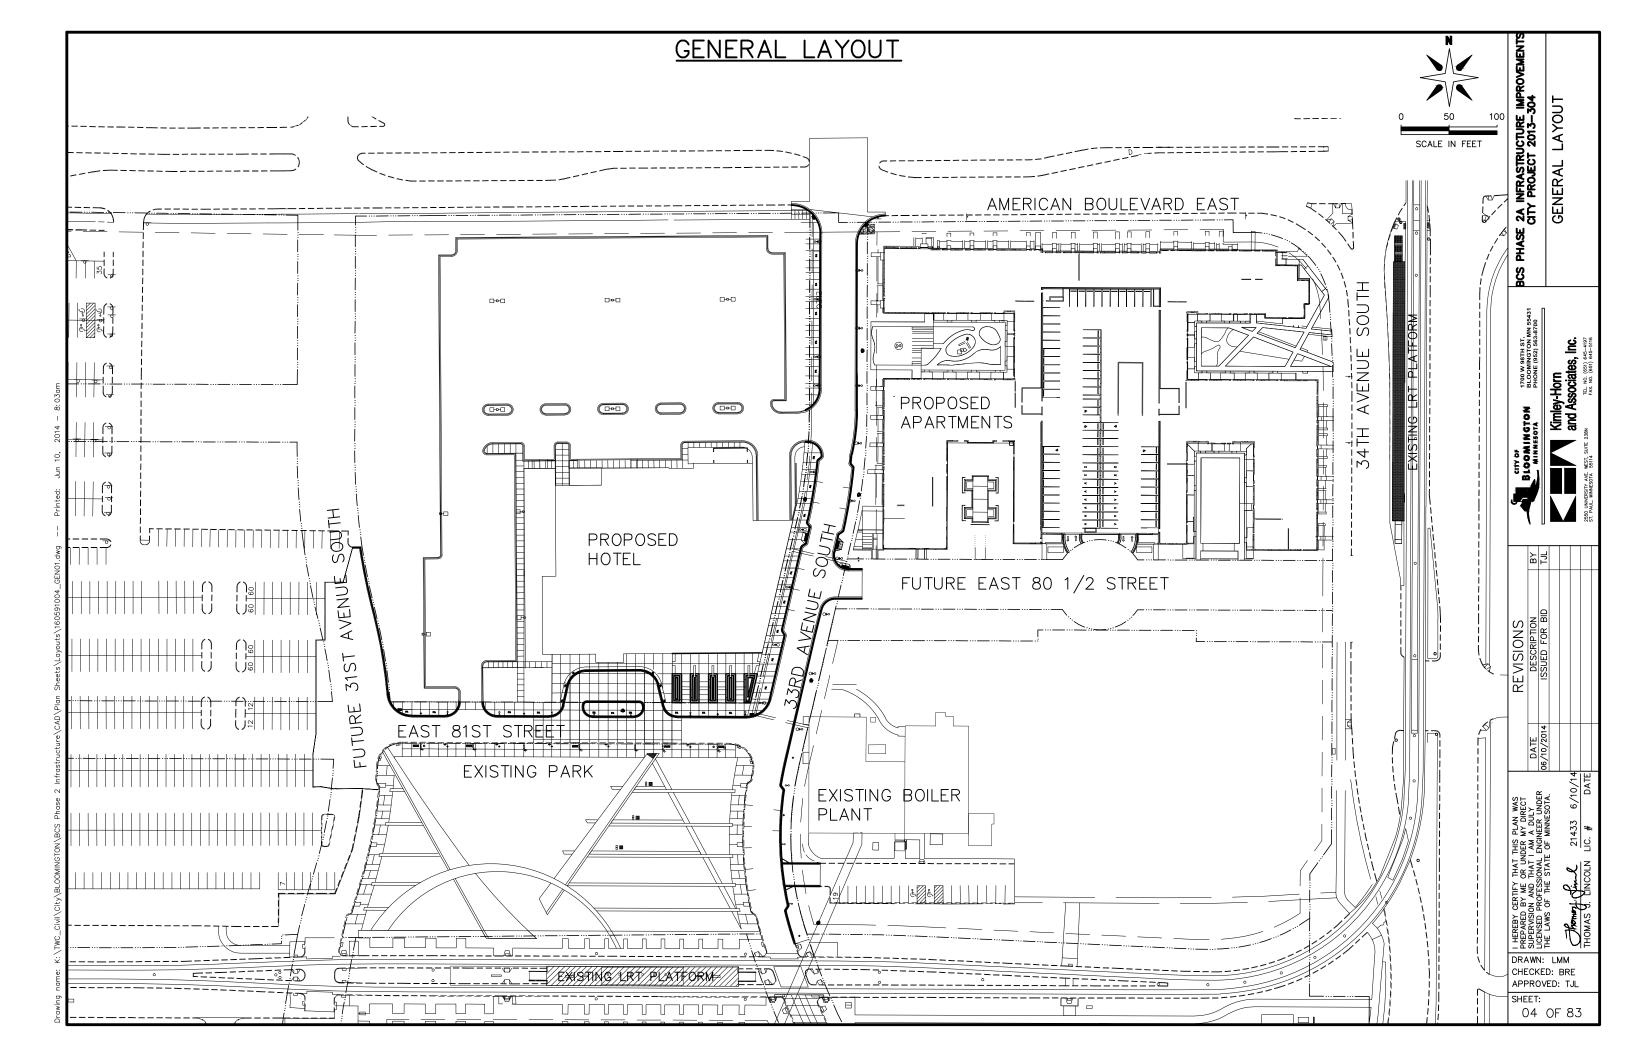

CONSTRUCTION NOTES

- SUITABLE GRADING MATERIAL ON THIS PROJECT SHALL CONSIST OF ALL SOILS ENCOUNTERED WITH THE EXCEPTION OF TOPSOIL, DEBRIS, ORGANIC MATERIAL, MUCK AND OTHER UNSTABLE MATERIAL AND SHALL MEET THE REQUIREMENTS OF GRANULAR
- 2. OTHER GRADING MATERIAL ON THIS PROJECT SHALL CONSIST OF ALL SOILS ENCOUNTERED ON THIS PROJECT EXCEPT DEBRIS.
- SELECT GRANULAR MATERIAL SHALL MEET THE REQUIREMENTS OF TABLE 3149-1.
- SUITABLE GRADING MATERIAL FROM ALL PORTIONS OF THE PROJECT SHALL BE USED IN FILL AREAS, AS REQUIRED, THROUGHOUT THE PROJECT.
- NO DISPOSAL SITE IS PROVIDED. ALL EXCESS GRADING MATERIAL SHALL BECOME THE PROPERTY OF THE CONTRACTOR FOR DISPOSAL. THE CONTRACTOR SHALL DISPOSE OF GRADING MATERIAL UNSUITABLE FOR USE IN THE CONSTRUCTION IN ACCORDANCE WITH PROVISIONS 2104.3D3 AND 2105.3I.
- 6. COMPACTION OF THE GRADING OF THE PROJECT SHALL BE BY THE "QUALITY COMPACTION METHOD" UNLESS OTHERWISE
- 7. CLEARING AND GRUBBING OF TREES AND SHRUBS SHALL BE RESTRICTED TO THOSE AS SHOWN ON PLAN OR AS APPROVED BY THE ENGINEER IN WRITING.
- BITUMINOUS SURFACING REMOVED BY CONSTRUCTION SHALL BECOME THE PROPERTY OF THE CONTRACTOR AND SHALL BE LEGALLY DISPOSED OF OFF THE PROJECT, IN ACCORDANCE WITH THE PROVISIONS OF 2104 AND 2105.
- 9. WHERE MATCHING INTO EXISTING ROADWAYS AT THE ENDS OF CONSTRUCTION, CUT VERTICALLY TO THE TOP OF THE GRADING SUBGRADE AND THEN AT A 20:1 TAPER TO THE BOTTOM OF THE RECOMMENDED SUBGRADE EXCAVATION.
- 10. GRADING GRADE (TOP OF GRADING SURFACE) IS DEFINED AS THE BOTTOM OF THE 26 INCH SUBCUT.
- 11. PROVIDE 20:1 TAPERS BETWEEN LONGITUDINAL CHANGES IN SUBCUT DEPTHS.
- 12. USE TACK COAT BETWEEN ALL BITUMINOUS MIXTURES. THE BITUMINOUS TACK COAT MATERIAL SHALL BE APPLIED AT THE UNIFORM RATE SPECIFIED. THE APPLICATION RATE IS FOR UNDILUTED EMULSIONS (AS SUPPLIED FROM THE REFINERY).
- 13. COMPACTION OF THE CLASS 5 AGGREGATE BASE FOR ALL AREAS TO RECEIVE BITUMINOUS SURFACING SHALL BE BY THE "PENETRATION INDEX METHOD".
- 14. COMPACTION OF THE BITUMINOUS MIXTURES SHALL BE BY THE "MAXIMUM DENSITY METHOD" UNLESS OTHERWISE SPECIFIED (SEE SPECIAL PROVISIONS).
- 15. STRIP AND REUSE AS SLOPE DRESSING ALL TOPSOIL AND EXISTING SLOPE DRESSING WHERE PRESENT IN AREAS TO BE DISTURBED BY CONSTRUCTION. ALL SLOPE DRESSING SHALL MEET THE REQUIREMENTS OF "COMMON TOPSOIL BORROW" (SPEC. 3877). TESTING OF SOILS USED SHALL BE REQUIRED AND IS THE RESPONSIBILITY OF THE CONTRACTOR.
- 16. PLACE A MINIMUM OF 4" TOPSOIL OR SLOPE DRESSING ON ALL AREAS DISTURBED BY CONSTRUCTION AND SCHEDULED FOR PERMANENT TURF ESTABLISHMENT.
- 17. ALL METAL PIPE INCLUDING VALVES, FITTINGS, AND APPURTENANCES, SHALL BE FULL ENCASED IN POLYETHYLENE FILM OF 8 MIL NOMINAL THICKNESS.
- 18. CONTRACTOR SHALL VERIFY INVERT ELEVATIONS OF EXISTING MANHOLES PRIOR TO ANY STORM SEWER CONSTRUCTION.
- 19. ALL DRIVEWAYS AND EXISTING STREETS SHALL BE SAW CUT AT MATCH POINTS OR EDGE MILLED CLEANLY.
- 20. BULKHEADING OF EXISTING PIPES SHALL BE INCIDENTAL TO OTHER STORM SEWER CONSTRUCTION.
- 21. THE SUBSURFACE UTILITY INFORMATION IN THIS PLAN IS UTILITY QUALITY LEVEL C. THIS UTILITY QUALITY LEVEL WAS DETERMINED ACCORDING TO THE GUIDELINES OF CE/ASCE 38-02, ENTITLED "STANDARD GUIDELINES FOR THE COLLECTION AND DEPICTION OF EXISTING SUBSURFACE UTILITY DATA.
- 22. REMOVE ALL SOILS AND SEDIMENT TRACKED OR OTHERWISE DEPOSITED ONTO PUBIC AND PRIVATE PAVEMENT AREAS. REMOVAL SHALL BE ON A DAILY BASIS WHEN TRACKING OCCURS. SWEEPING SHALL BE MAINTAINED THROUGHOUT THE DURATION OF CONSTRUCTION AND DONE IN A MANNER TO PREVENT DUST BEING BLOWN INTO ADJACENT PROPERTIES
- 23. INSTALL INLET PROTECTION AT ALL CATCH BASIN INLETS, WHICH RECEIVE RUNOFF FROM THE DISTURBED AREAS. CATCH BASIN INSERTS ARE REQUIRED IN UNDISTURBED AREAS THAT RECEIVE RUNOFF FROM DISTURBED AREAS.

GENERAL NOTES

1. WORK ZONE REQUIREMENTS:

- CONTRACTOR SHALL MAINTAIN ALL DRIVING LANES IN EACH DIRECTION ON STREET ABUTTING PROJECT UNLESS OTHERWISE APPROVED BY THE ENGINEER.
- ACCESS TO ALL DRIVEWAYS SHALL BE MAINTAINED AT ALL TIMES;
- CONTRACTOR MUST PHASE WORK SO AS TO KEEP LANES OF TRAVEL FREE FROM ANY CONSTRUCTION EQUIPMENT AT ALL TIMES.
- 2. REMOVE CURB AND GUTTER, CONCRETE WALK, AND BITUMINOUS PAVEMENT AS APPROVED BY THE ENGINEER.
- 3. REMOVE CATCH BASINS, MANHOLES, AND SEWER PIPE AS SHOWN.
- 4. CONSTRUCT PAVEMENT SECTIONS AS SHOWN ON THE PLAN AND TYPICAL SECTIONS.
- 5. LANDSCAPE AS APPROVED BY THE ENGINEER.
- PROPERTY LINES AND R.O.W. LINES ARE SHOWN IN APPROXIMATE LOCATIONS ONLY.
- EROSION CONTROL MEASURES SHALL BE APPROVED BY THE ENGINEER, AND ARE NOT NECESSARILY LIMITED TO THOSE IN THE PLAN SET.

THE FOLLOWING STANDARD PLATES APPROVED BY FHWA SHALL APPLY ON THIS PROJECT.

	MN/DOT STANDARD PLATES
PLATE NO.	DESCRIPTION
1150R	CONCRETE HEADER JOINTS — TERMINAL HEADERS
4003B	30" PRECAST CATCH BASIN — DESIGN N
7111J	INSTALLATION OF CATCH BASIN CASTINGS
8337	TEMPORARY PORTABLE PRECAST CONCRETE BARRIER

	MN/DOT STANDARD PLANS
PLATE NO.	DESCRIPTION
5-297.221	PAVEMENT JOINTS

	BCS PHASE 2A EARTHWORK SUMMARY
EXCAVATION	4,600 CY (CV)
EMBANKMENT	-200 CY (CV)
	BCS PHASE 2A EARTHWORK SUMMARY

- 1. COMMON EXCAVATION INCLUDES EXCAVATION TO THE GRADING GRADE (BOTTOM OF THE SELECT GRANULAR) AND EXCLUDES EXISTING AND PROPOSED PAVEMENT QUANTITIES (5,810 CY) AND INCLUDES EXISTING AND PROPOSED TOPSOIL QUANTITIES.
- EXCESS MATERIAL SHALL BE STOCKPILED IN THE FUTURE 80 1/2 STREET RIGHT-OF-WAY. CONTRACTOR TO MAINTAIN 20' MIN. ACCESS CORRIDORS TO THE ADJACENT CONSTRUCTION PROJECTS AT ALL
- UTILITY EXCAVATION IS NOT INCLUDED IN EXCAVATION TOTALS.

IMPROVEMENT 304 INFRASTRUCTURE PROJECT 2013—:

PHASE


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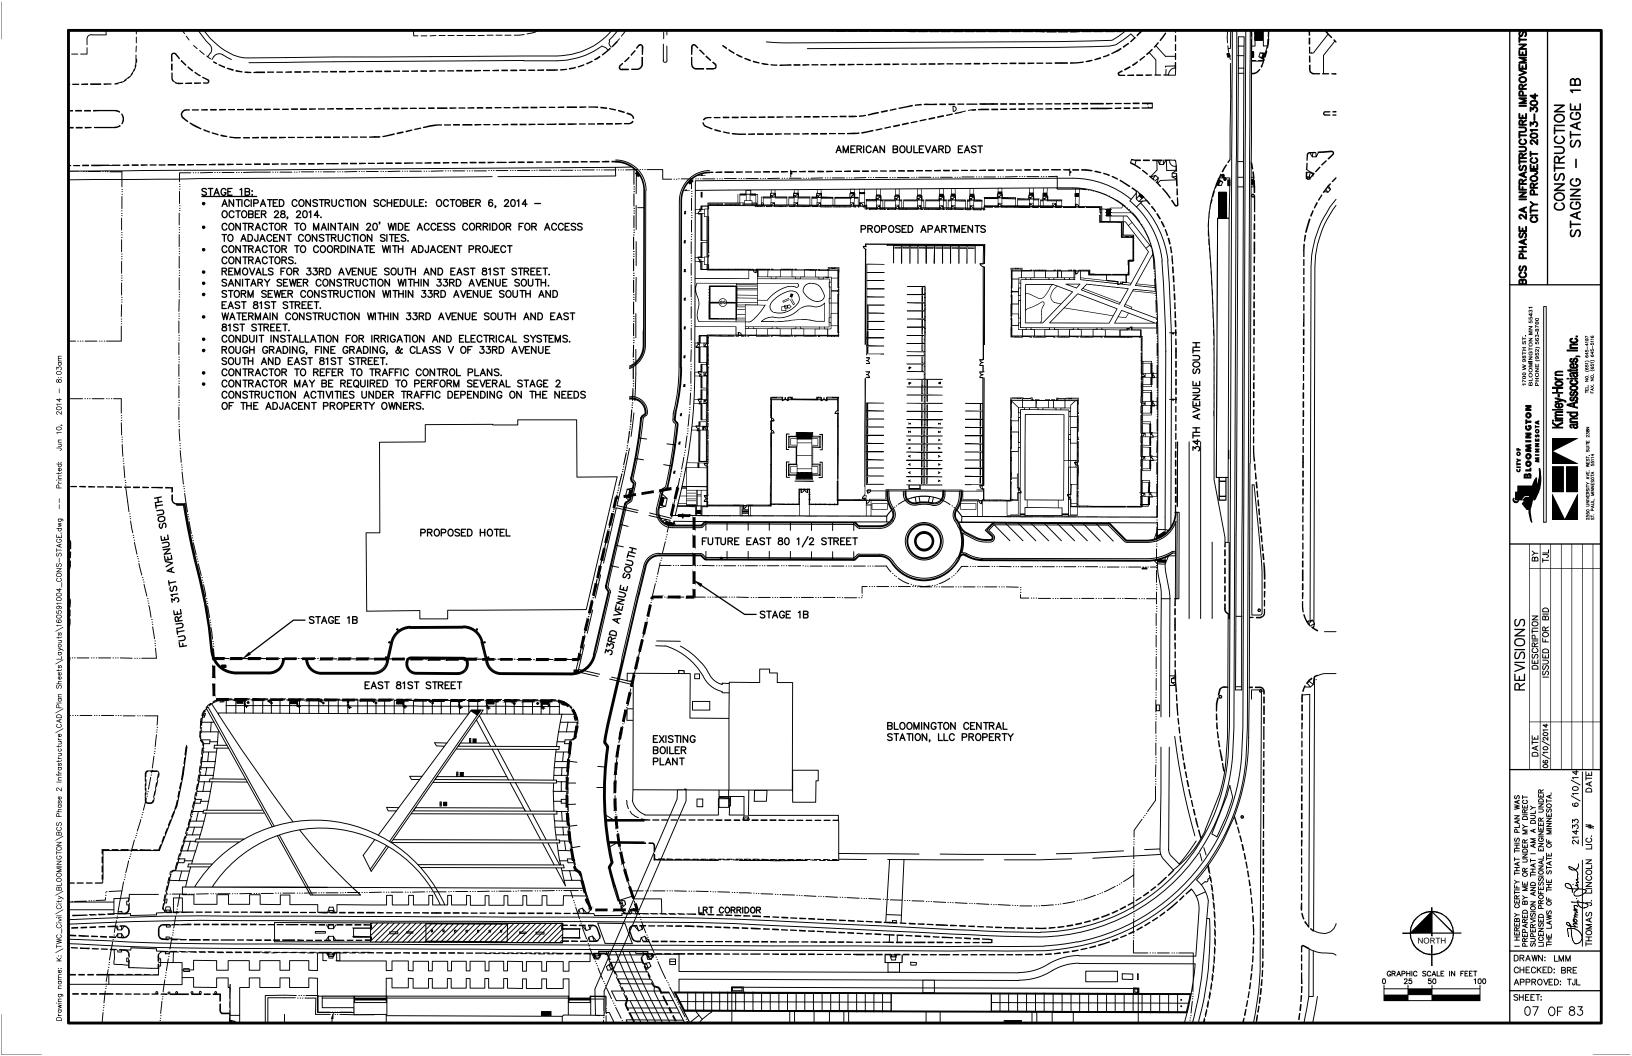
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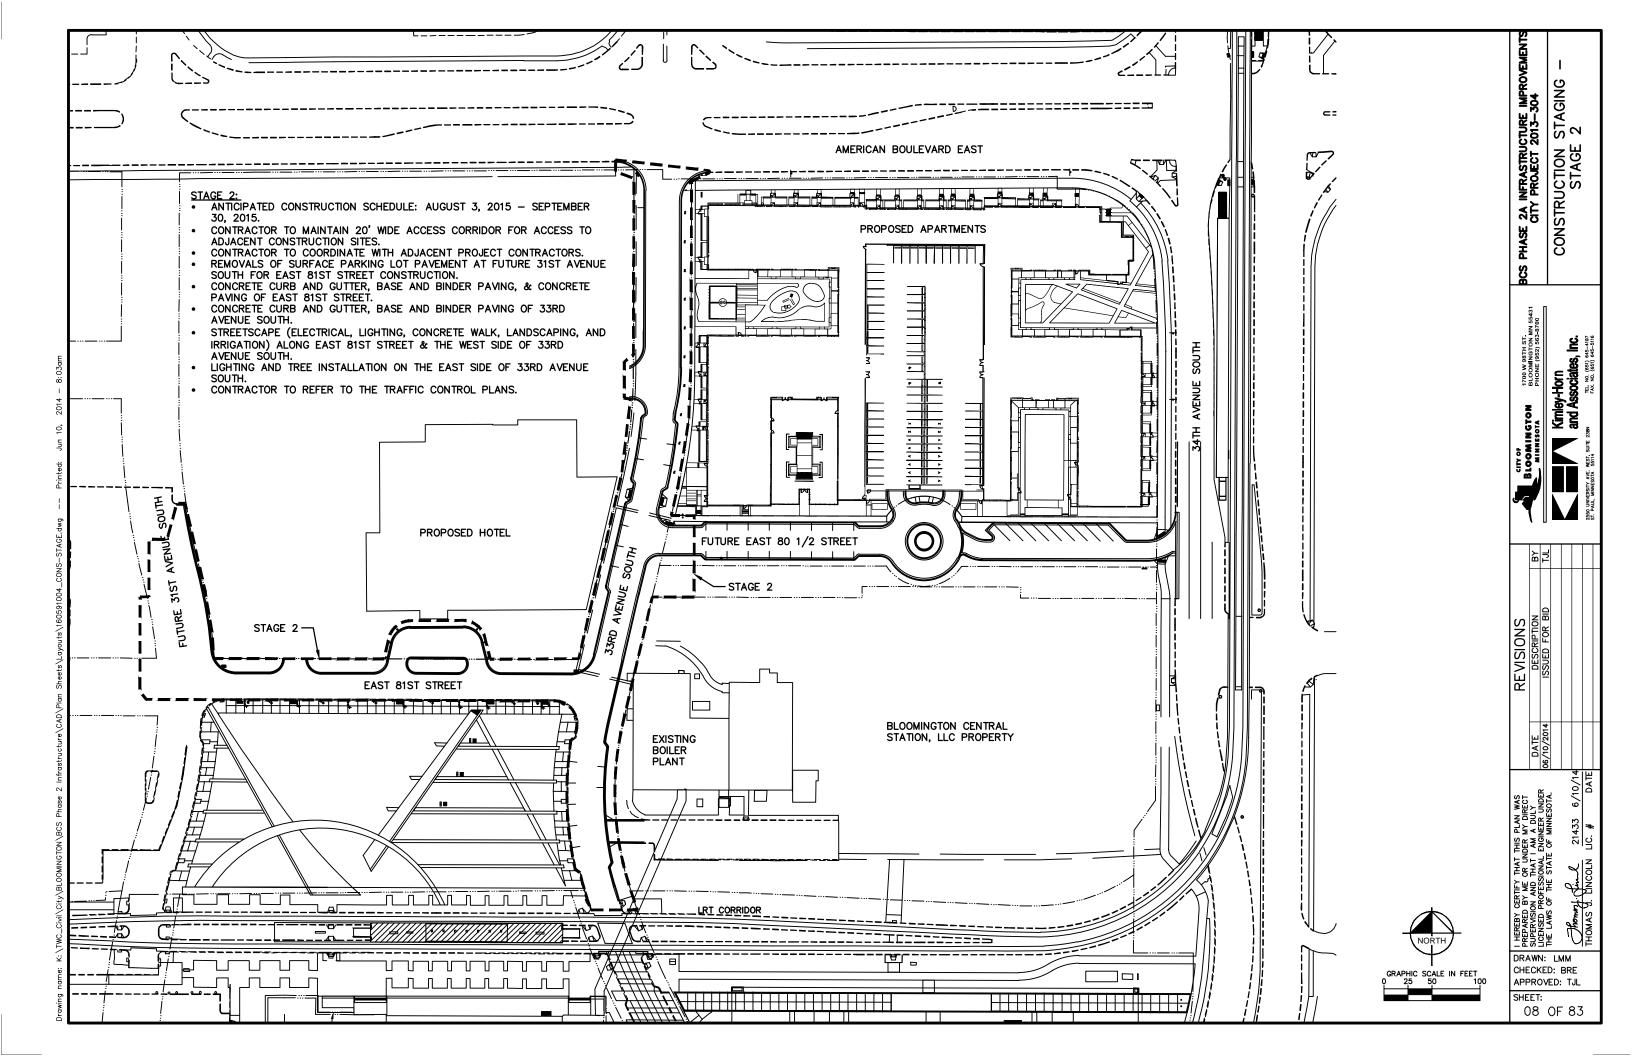
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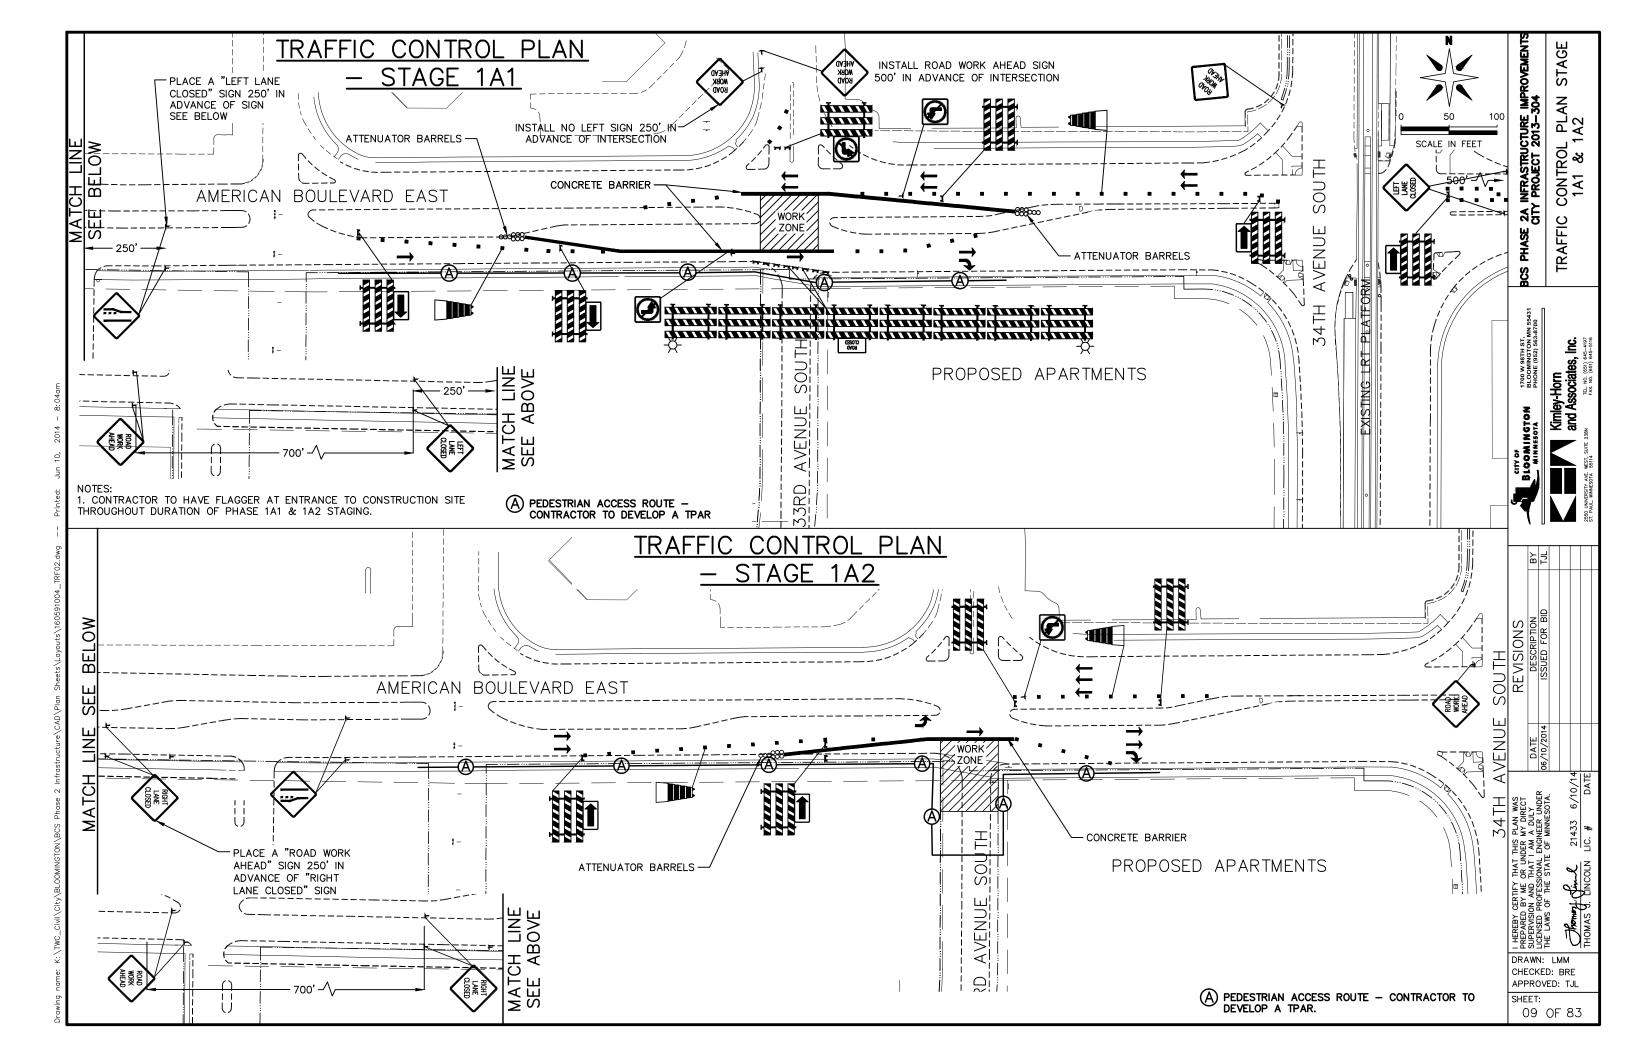
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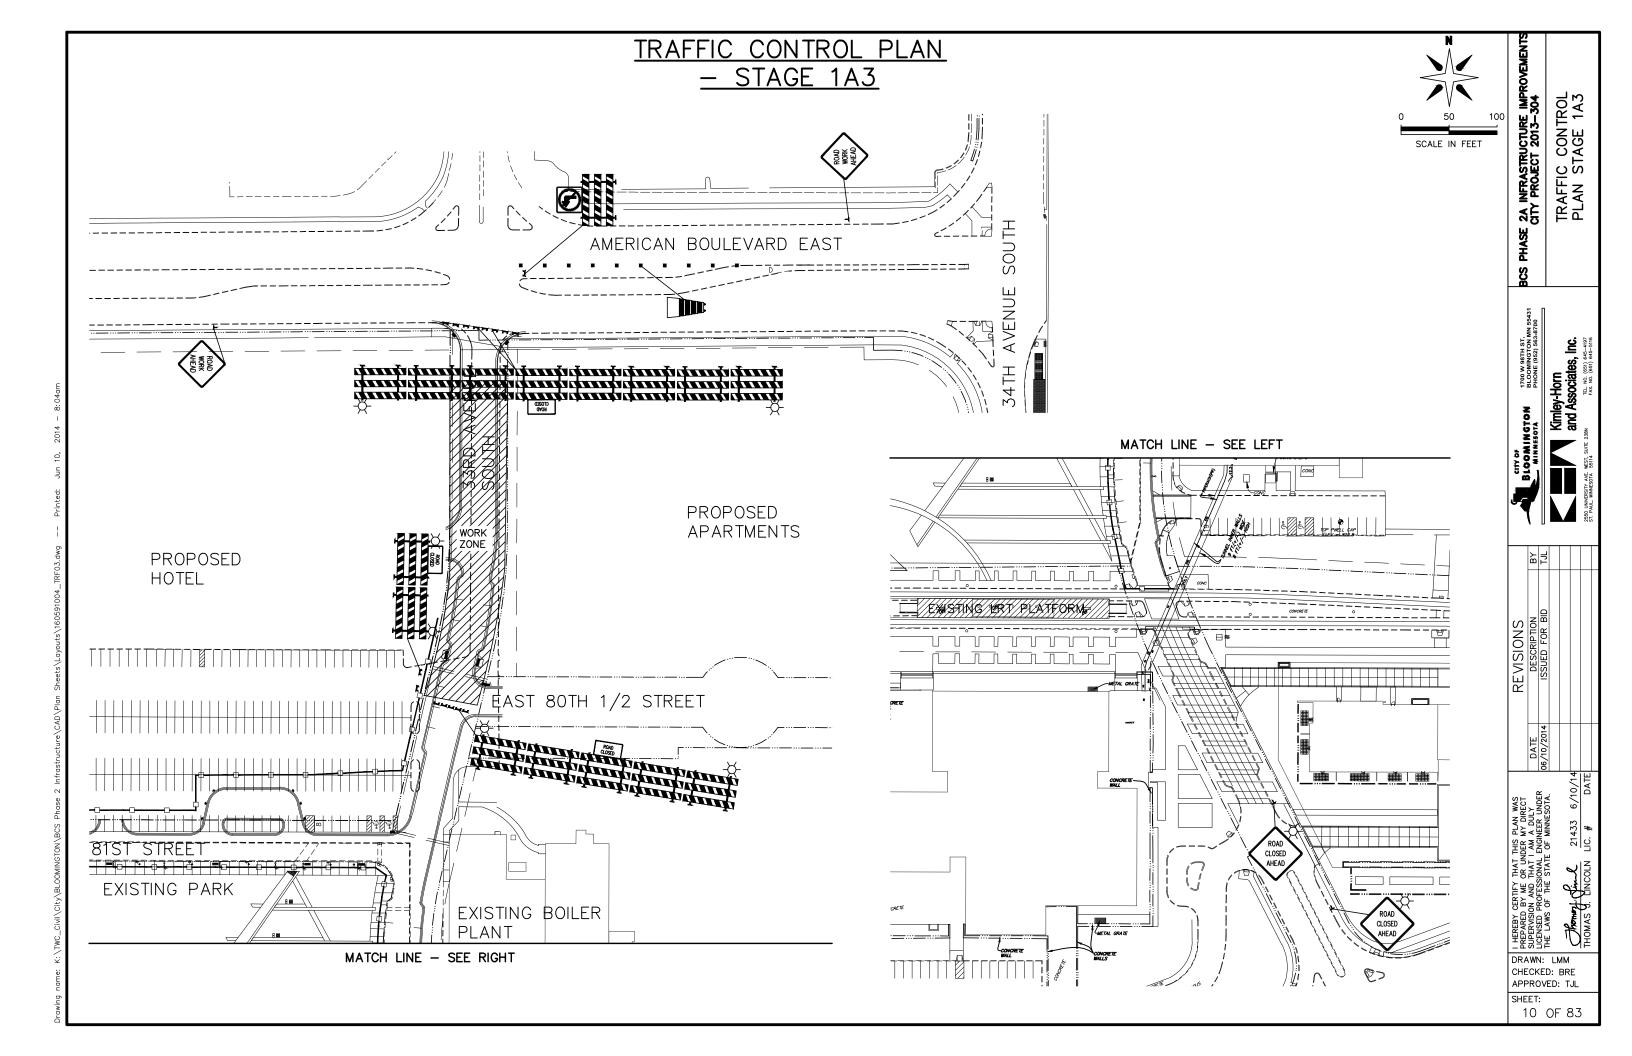
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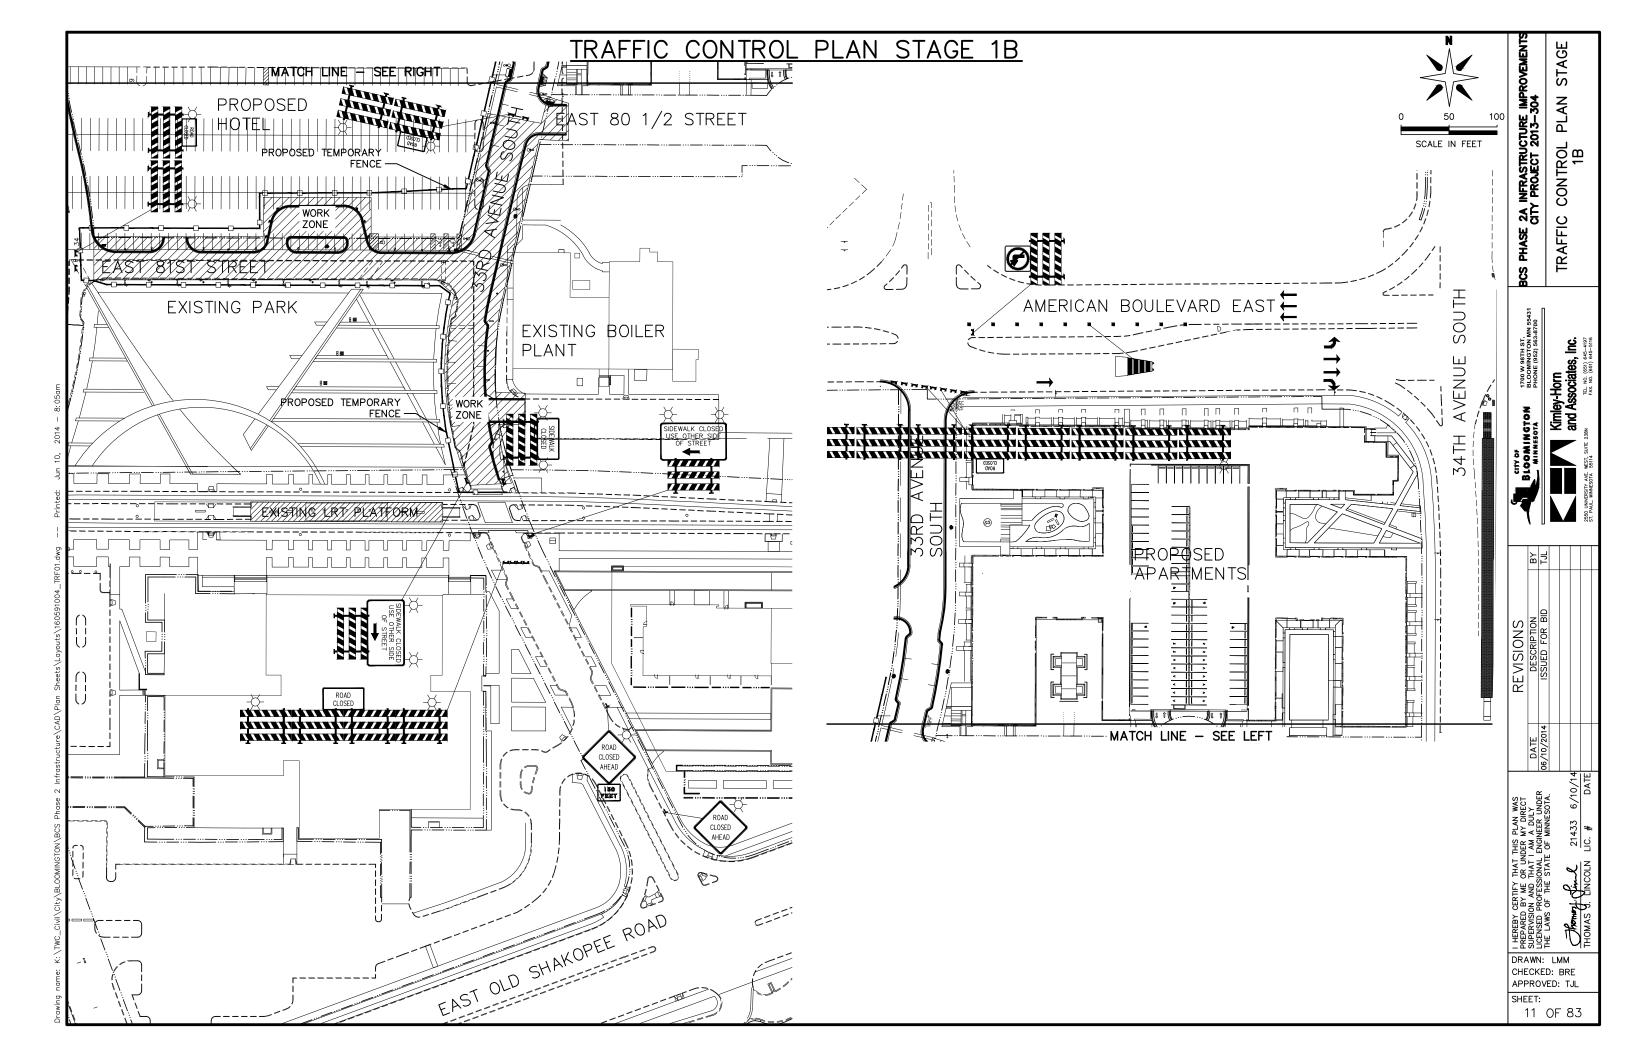











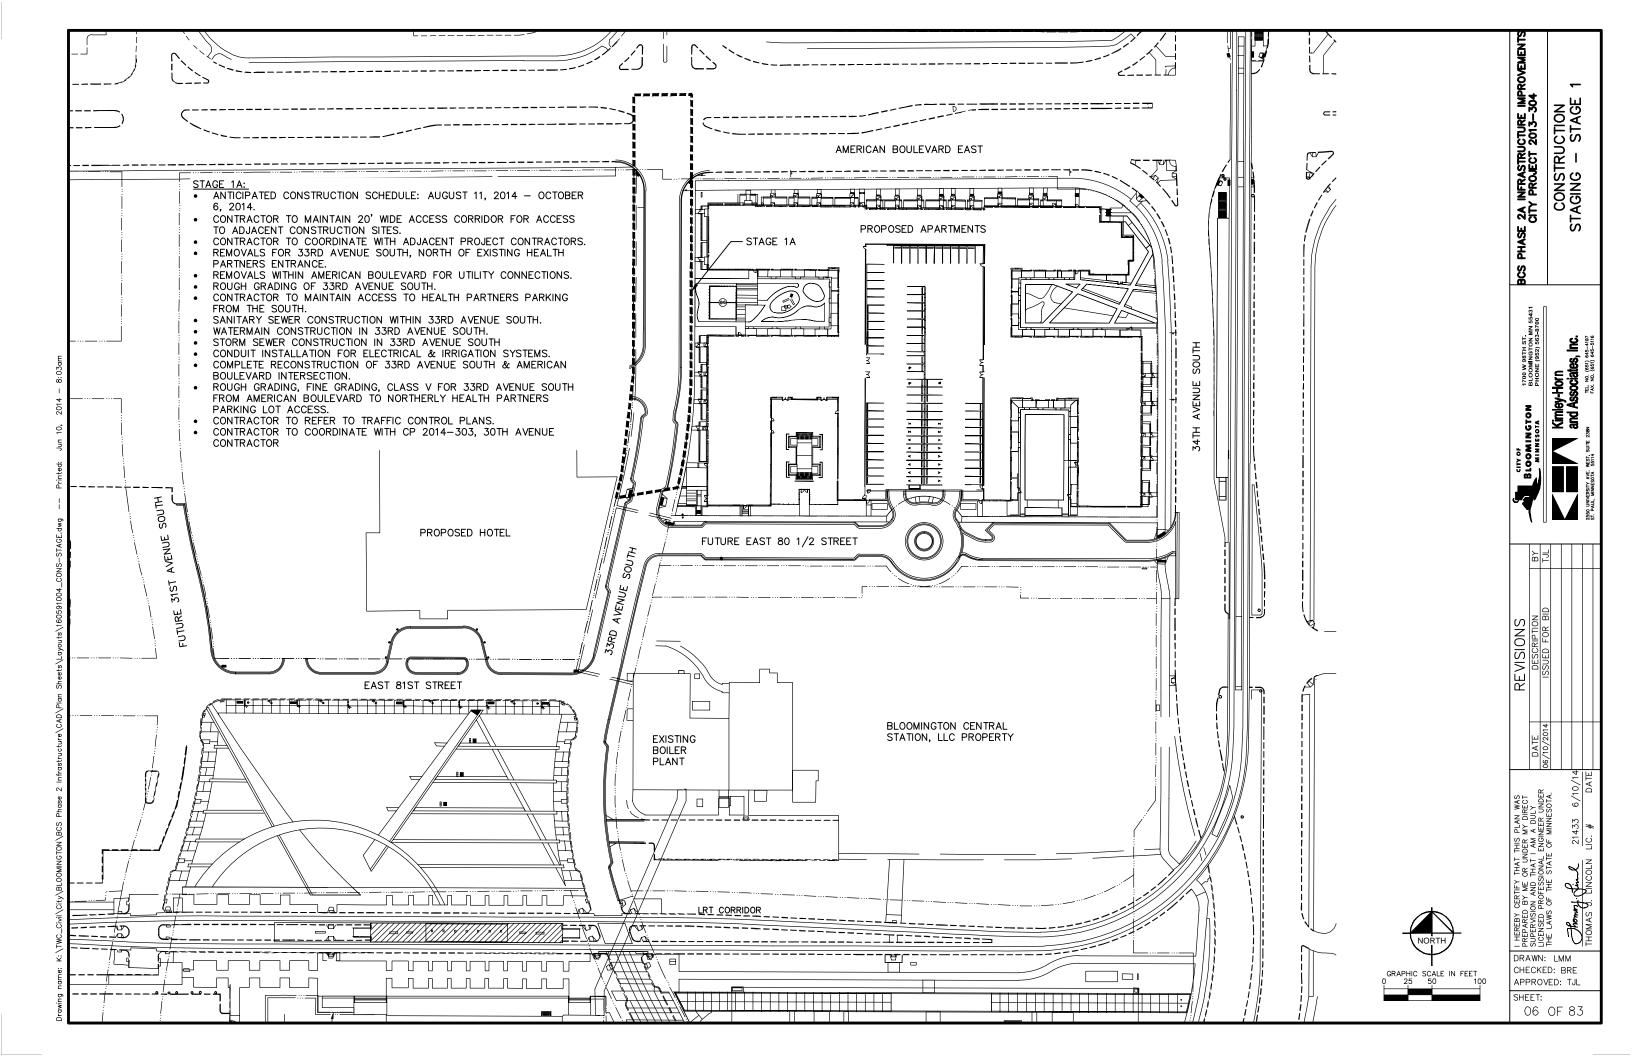

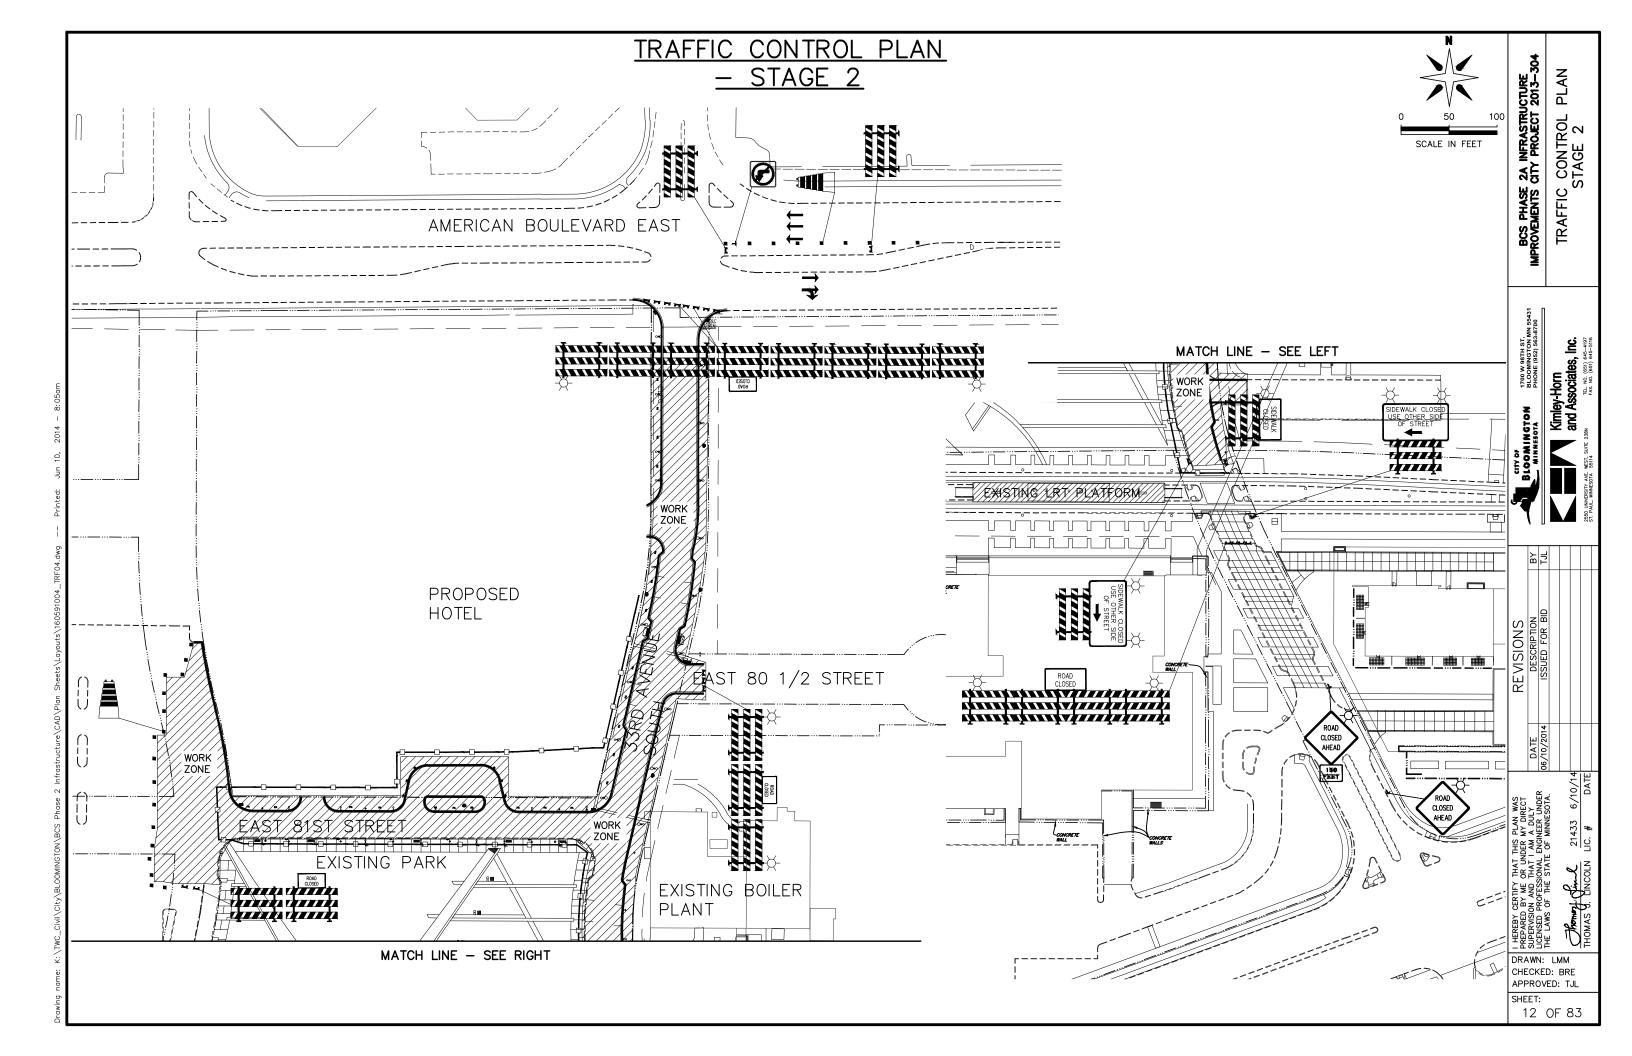

		"W" SERIES							
ITEM	SIGN NO.	DESCRIPTION	COLOR	SIZE	STAGE 1A1	STAGE 1A2	STAGE 1A3	STAGE 1B	STAGE 2
ROAD WORK AHEAD	W20-1	ROAD WORK AHEAD	BLACK ON ORANGE	36 x 36	4	2	2	0	0
ROAD CLOSED AHEAD	W20-3	ROAD CLOSED AHEAD	BLACK ON ORANGE	36 x 36	0	0	2	2	2
LEFT LANE Q.OSED	W21-X5L	LEFT LANE CLOSED	BLACK ON ORANGE	36 x 36	2	0	0	0	0
RIGHT LANE CLOSED	W21-X5R	RIGHT LANE CLOSED	BLACK ON ORANGE	36 x 36	0	2	0	0	0
	W1-6R	ARROW (RIGHT)	BLACK ON ORANGE	24 X 12	4	0	0	0	0
	W1-6L	ARROW (LEFT)	BLACK ON ORANGE	24 X 12	0	2	0	0	0
(t)	W4-1R	MERGE	BLACK ON ORANGE	36 x 36	0	0	0	0	0
	W4-2L	LANE ENDS	BLACK ON ORANGE	36 x 36	1	1	0	0	0
ROAD CLOSED	R11-2	ROAD CLOSED	BLACK ON WHITE	48 × 30	0	0	3	4	4

		"R" SERIES							
ITEM	SIGN NO.	DESCRIPTION	COLOR	SIZE	STAGE 1A1	STAGE 1A2	STAGE 1A3	STAGE 1B	STAGE 2
3	R3-1	NO LEFT TURN	BLACK & RED ON WHITE	24 × 24	3	1	1	1	1
YIELD	R1-2	YEILD	RED ON WHITE	30 X 30	0	0	0	0	0
SIDEWALK CLOSED	R9-9	SIDEWALK CLOSED	BLACK & RED ON WHITE	30 X 24	0	0	0	1	1
SIDEWALK CLOSED USE OTHER SIDE OF STREET	R9-11BR	SIDEWALK CLOSED USE OTHER SIDE OF STREET	BLACK ON WHITE	24 X 12	0	0	0	1	1
SIDEWALK CLOSED USE OTHER SIDE OF STREET	R9-11BL	SIDEWALK CLOSED USE OTHER SIDE OF STREET	BLACK ON WHITE	24 x 12	0	0	1	1	1

		SPECIAL							
ITEM	SIGN NO.	DESCRIPTION	COLOR	SIZE	STAGE 1A1	STAGE 1A2	STAGE 1A3	STAGE 1B	STAGE 2
\	SPECIAL	LIGHT			2	0	6	14	14

		DEVICES					
ITEM	SIGN NO.	COLOR	STAGE 1A1	STAGE 1A2	STAGE 1A3	STAGE 1B	STAGE 2
	TYPE III BARRICADE	ORANGE ON WHITE	14	4	16	14	22
Ä	DRUM	ORANGE ON WHITE	53	26	10	10	26
\$\$\$poo	ATTENUATOR BARRELS		2 SETS	1 SETS	0	0	0

BCS PHASE 2A INFRASTRUCTURE IMPROVEMENT CITY PROJECT 2013-304 TRAFFIC CONTROL TABULATION

BLOOM INGTON TOOW SETH ST. BLOOMINGTON MN 55431 PHONE (952) 563-4700 Kimley-Horn and Associates, Inc. 1260 UNIVESSITY ARE WEST, SUITE 238N TEAU, WINNESSITY ASSURES SENT TEAU, (551) 645-5116

REVISIONS
DESCRIPTION
ISSUED FOR BID 21433 6/10/14 LIC. # DATE

HEREBY CERTIFY THAT THIS PLAN WAS PREPARED BY ME OF WINDER WY DIRECT SUPERFOXION BY ME OF WINDER WY DIRECT SUPERFOXION BY ME OF THE STATE OF MINNESOTA.

HE LAWS OF THE STATE OF MINNESOTA.

HE LAWS OF THE STATE OF MINNESOTA.

SHEET: 13 OF 83

TRAFFIC CONTROL NOTES AND GUIDELINES

GENERAL INFORMATION:

- QUANTITIES PROVIDED ARE APPROXIMATE. TRAFFIC CONTROL BID ITEM IS LUMP SUM. THE LOCATIONS AND QUANTITIES OF TRAFFIC CONTROL DEVICES SHOWN ON THESE PLANS ARE APPROXIMATE, NOT ALL INCLUSIVE, AND ARE SUBJECT TO REVISION BY THE ENGINEER.
- ALL TRAFFIC CONTROL DEVICES, TEMPORARY LANE CLOSURE ARRANGEMENTS AND PROCEDURES ETC., SHALL CONFORM WITH THE REQUIREMENTS OF THE CURRENT EDITION OF THE MINNESOTA MANUAL ON UNIFORM TRAFFIC CONTROL DEVICES INCLUDING THE FIELD MANUAL FOR TEMPORARY TRAFFIC
- 3. REFLECTORIZED DRUMS USED FOR CHANNELIZATION SHALL HAVE SPACING AS NOTED IN THE PLANS. DRUM LOCATIONS AND SPACINGS SHOWN ON THIS PLAN ARE APPROXIMATE AND ARE SUBJECT TO REVISION BY THE ENGINEER AND TRAFFIC CONTROL SUPERVISOR.
- 4. THE CONTRACTOR SHALL MAINTAIN A 2 FOOT MINIMUM CLEAR DISTANCE BETWEEN THE EDGE OF THE TRAVEL LANE AND THE NEAREST EDGE OF ANY ADJACENT TRAFFIC CONTROL DEVICE (DRUMS, BARRICADES, BARRIERS, ETC.) UNLESS OTHERWISE NOTED.
- REMOVE CONFLICTING TRAFFIC CONTROL SIGNS AND PAVEMENT MARKINGS AS DIRECTED BY ENGINEER.
- THE CONTRACTOR SHALL FURNISH, INSTALL AND MAINTAIN THE DEVICES IN THIS TRAFFIC CONTROL
- 7. FIELD CONDITIONS MAY REQUIRE MODIFICATIONS OF THE TRAFFIC CONTROL PLAN. ANY MODIFICATIONS SHALL BE APPROVED BY THE ENGINEER IN THE FIELD PRIOR TO CHANGES BEING
- 8. ALL DISTANCES ARE APPROXIMATE.
- 9. ALL TEMPORARY TRAFFIC THRU LANES SHALL BE A MINIMUM OF 11 FEET IN WIDTH UNLESS NOTED
- 10. THE CONTRACTOR IS RESPONSIBLE FOR PROTECTING ANY WORK AREAS NEAR TRAFFIC IN
- 11. IF THE CONTRACTOR DECIDES TO PERFORM THE CONSTRUCTION WORK IN A SEQUENCE OTHER THAN SHOWN IN THIS TRAFFIC CONTROL PLAN, THE CONTRACTOR SHALL PROVIDE COMPLETE REVISED TRAFFIC CONTROL PLANS TO BE APPROVED BY THE ENGINEER.
- 12. SIGN INSTALLATIONS SHALL NOT OBSTRUCT EXISTING SIGNS.
- 13. THE CONTRACTOR SHALL MAINTAIN ACCESS TO ALL DRIVEWAYS THAT ARE TO REMAIN OPEN AT ALL TIMES TO THE SATISFACTION OF THE ENGINEER.
- 14. THE CONTRACTOR SHALL WORK WITH THE POSTAL SERVICE TO ESTABLISH A PLAN FOR THE MAINTENANCE OF MAIL DELIVERY DURING CONSTRUCTION. ANY COSTS TO ESTABLISH TEMPORARY MAILBOXES SHALL BE INCIDENTAL TO THE PROJECT CONSTRUCTION.
- 15. THE TRAFFIC CONTROL AND STAGING PLANS DEPICT A GENERAL PLAN FOR MAINTAINING TRAFFIC. ADDITIONAL TRAFFIC CONTROL WILL BE REQUIRED TO COMPLETE SPECIFIC PORTIONS OF THE PROJECT. ADDITIONAL TRAFFIC CONTROL REQUIRED BY THE PROJECT, BUT NOT DEPICTED ON THESE PLANS, SHALL BE INCIDENTAL TO THE LUMP SUM BID ITEM.
- 16. THE CONTRACTOR SHALL PROVIDE CHANNELIZING DEVICES (AND SIGNING IF APPROVED BY THE ENGINEER) AT ALL PRIVATE ENTRANCE LOCATIONS WHERE NEEDED TO SAFELY GUIDE TRAFFIC TO AND FROM THE TRAVEL CORRIDOR TO THE SATISFACTION OF THE ENGINEER.
- 17. THE CONTRACTOR SHALL PROVIDE QUALIFIED FLAGGERS WITH TWO-WAY RADIOS AT ALL TIMES WHEN CONTRACTOR OPERATIONS REQUIRE ONE—LANE—TWO—WAY OPERATION OR WHEN IN THE OPINION OF THE ENGINEER, ONE—LANE—TWO—WAY OPERATIONS ARE APPROPRIATE DUE TO SAFETY CONCERNS FROM OPEN EXCAVATIONS, ADJACENT EQUIPMENT, ETC.
- 18. IN ALL WORK AREAS CONSTRUCTED UNDER TRAFFIC THE CONTRACTOR SHALL PROTECT THESE AREAS AT ALL TIMES TO PROVIDE FORSAFE TRAFFIC MOVEMENT TO THE SATISFACTION OF THE ENGINEER.
- 19. MISCELLANEOUS CONSTRUCTION ACTIVITIES WHICH TAKE PLACE OUT OF SEQUENCE WITH THE STAGING PLAN SHALL HAVE TRAFFIC CONTROL WHICH ADHERES TO TEMPORARY LANE CLOSURE GUIDELINES AND REQUIREMENTS FOR STATIONARY TRAFFIC CONTROL AS SHOWN IN THE MN MUTCD, SECTION 6.
- 20. THE CONTRACTOR SHALL MAKE EVERY EFFORT TO OPEN SIDE STREETS AND OTHER PROTIONS OF THE ROADWAY EARLY. AS CONSTRUCTION ALLOWS.
- 21. THE ACTUAL NUMBER OF BARRICADES AT EACH LOCATION REQUIRED MAY VARY DEPENDING UPON THE SIZE OF THE BARRICADES USED, THE WIDTH OF THE ROAD CLOSURE AND THE MOVEMENT OF
- 22. THE CONTRACTOR SHALL MAINTAIN LOCAL ACCESS TO ABUTTING PROPERTY AT ALL TIMES. SEE SPECIAL PROVISIONS FOR DETAILS.
- 23. THE CONTRACTOR SHALL PERFORM MAINTENANCE OF AGGREGATE SURFACING IN AREAS INDICATED BY THE ENGINEER WITHIN 24 HOURS OF REQUEST. (INCIDENTAL)

WINTER TRAFFIC CONTROL

- ALL TEMPORARY TRAFFIC CONTROL DEVICES DEEMED UNNECESSARY BY THE ENGINEER, SHALL BE REMOVED FROM THE PROJECT LIMITS OR STORED IN THE CONTRACTOR'S STAGING AREA.
- 2. AN ANNUAL FALL REVIEW OF ALL TRAFFIC CONTROL ITEMS BY THE CONTRACTOR AND CITY WILL BE MADE TO PREPARE FOR WINTER MAINTENANCE OF THE PROJECT. THIS MAY INCLUDE ADJUSTMENTS OR EXCHANGE OF ONE TRAFFIC CONTROL DEVICE FOR ANOTHER. READJUSTMENTS MAY AGAIN BE REQUIRED DURING WINTER AND IN THE

SIGNING:

- ALL TRAFFIC CONTROL DEVICES, INCLUDING OVERHEAD SIGNS ON ROADS OPEN TO TRAFFIC THAT ARE NOT CONSISTENT WITH TRAFFIC OPERATION SHALL BE COVERED. REMOVED OR REVISED AS DIRECTED BY THE ENGINEER.
- 2. WHEN SIGNS ARE INSTALLED, THEY SHALL BE MOUNTED ON POSTS DRIVEN INTO THE GROUND AT THE PROPER HEIGHT AND LATERAL OFFSET AS DETAILED IN THE MN MUTCD. IF THIS IS NOT POSSIBLE, THEY WILL BE MOUNTED ON PORTABLE SUPPORTS AS APPROVED BY THE ENGINEER. WHEN THE SIGNS ARE REMOVED, THE SIGN POSTS SHALL BE REMOVED AS SOON
- 3. ALL ORANGE SIGNS SHALL BE MADE OF HIGH PERFORMANCE SIGN SHEETING
- LONGITUDINAL DROPOFFS SHALL BE SIGNED AS SHOWN IN THE JANUARY 2014 MNDOT "TEMPORARY TRAFFIC CONTROL ZONE LAYOUTS" FIELD MANUAL, FIGURES 6K-3, 6K-4, & 6K-5 UNLESS OTHERWISE SPECIFIED IN
- THE CONTRACTOR SHALL COORDINATE THE INSTALLATION OF THE FINAL SIGNS TO ASSURE THAT THE FINAL SIGNS ARE INSTALLED AS NEEDED, OR PROVIDE TEMPORARY SIGNING AT THEIR EXPENSE UNTIL THE FINAL SIGNING
- 6. THESE TRAFFIC CONTROL LAYOUTS DO NOT SHOW ALL EXISTING SIGNING. CONTRACTOR SHALL RELOCATE ALL APPROPRIATE EXISTING SIGNING TO MAINTAIN PROPER SIGN VISIBILITY DURING CONSTRUCTION AS DEEMED NECESSARY BY THE ENGINEER.
- THE CONTRACTOR SHALL FURNISH, INSTALL, MAINTAIN, SALVAGE AND REMOVE, AS APPROPRIATE, ALL SIGNS, PAVEMENT MARKINGS, AND DEVICES SHOWN ON THESE PLANS TO THE SATISFACTION OF THE ENGINEER.
- 8. ALL SIGNS AND TRAFFIC CONTROL ITEMS SHALL BE LIKE NEW AND REFECT UNIFORMLY AT NIGHT.
- SPACING OF SIGNS AND TRAFFIC CONTROL DEVICES MAY BE ADJUSTED AS APPROVED BY THE ENGINEER.
- 10. THE CONTRACTOR SHALL BE RESPONSIBLE FOR ANY EXTRA SIGNING NEEDED TO FACILITATE TRAFFIC SWITCHES OR FOR TRANSITIONING TRAFFIC FROM ONE STAGE TO ANOTHER.

PAVEMENT MARKING:

- OBLITERATE ANY CONFLICTING PAVEMENT MARKINGS AS DIRECTED BY THE
- 2. POLYMER LANE TAPE IS AN ACCEPTABLE TEMPORARY STRIPING ALTERNATE ACCORDING TP ACTUAL CONDITIONS ENCOUNTERED AS DIRECTED BY THE
- 3. THE CONTRACTOR SHALL BE RESPONSIBLE FOR THE LOCATION AND COORDINATION OF THE INSTALLATION OF TEMPORARY AND FINAL STRIPING TO ASSURE THAT THE MARKINGS ARE INSTALLED AS NEEDED, BLOOMINGTON TRAFFIC PERSONNEL WILL ASSIST IN THE GENERAL SPOTTING OF TRANSITION AREA, GORES AND TAPERS AS INDICATED IN THE SPECIFICATIONS.

BARRIER & DELINEATION:


- 1. TOP MOUNTED BARRIER DELINEATORS SHALL HAVE A MINIMUM OF 24 SQ. IN. OF REFLECTIVE SURFACE AREA AND ARE PLACED AT 30' SPACES ON TOP OF THE BARRIER WHEN THE BARRIER IS WITHIN 10' OF TRAFFIC UNLESS OTHERWISE NOTED OR AS DEEMED UNNECESSARY BY THE ENGINEER. IF THE TRAFFIC ENGINEER REQUIRES SIDE MOUNTED BARRIER DELINEATORS, THEY SHALL HAVE A MINIMUM OF 12 SQ. IN. OF REFLECTIVE SURFACE AREA AND BE PLACED AT 30 FT SPACES. IF A SMALLER APPROVED BARRIER DELINEATOR IS USED IT SHALL BE AT ONE HALF THE SPACING. BARRIER DELINEATOR, IF REQUIRED, ARE INCIDENTAL
- 2. THE CONTRACTOR SHALL FURNISH AND INSTALL TEMPORARY PRECAST CONCRETE BARRIER WITH APPROPRIATE IMPACT ATTENUATORS OR WATER FILLED BARRIER TO PROTECT TRAFFIC FROM OPEN EXCAVATIONS WHEREVER ALLOWABLE LONGITUDINAL DROP-OFFS PER THE FIELD MANUAL ARE **EXCEEDED**
- 3. THE CONTRACTOR SHALL DETERMINE THE NEED FOR BARRIER BASED ON THEIR CONSTRUCTION MEANS AND METHODS. TEMPORARY BARRIER NOT SPECIFICALLY SHOWN IN THE PLANS, BUT DETERMINED AS NECESSARY FOR CONSTRUCTION BY THE CONTRACTOR SHALL BE INCIDENTAL.
- 4. ONCE THE EXCAVTIONS ARE BACKFILLED AND THE DRIVING SURFACE ADEQUATELY RESTORED, TEMPORARY BARRIER SHALL BE REMOVED.
- 5. ANY TEMPORARY PORTABLE CONCRETE BARRIER USED ON THIS PROJECT SHALL BE PLACED AS DETAILED IN THE MN MUTCD FIGURE 6F-9. SEE STAGING AND TRAFFIC CONTROL PLANS FOR DESIGN SPEED ON IMPACT ATTENUATOR TO BE USED. TRAFFIC BARRIER SHALL HAVE A BARRIER DELINEATORS SPACED AT 30 FT. WITH A MINIMUM AREA OF 24 SQ. IN.


INFRASTRUCTURE PROJECT 2013-TROL \circ ٩₹ **TRAFFI** PHASE


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SHEET:






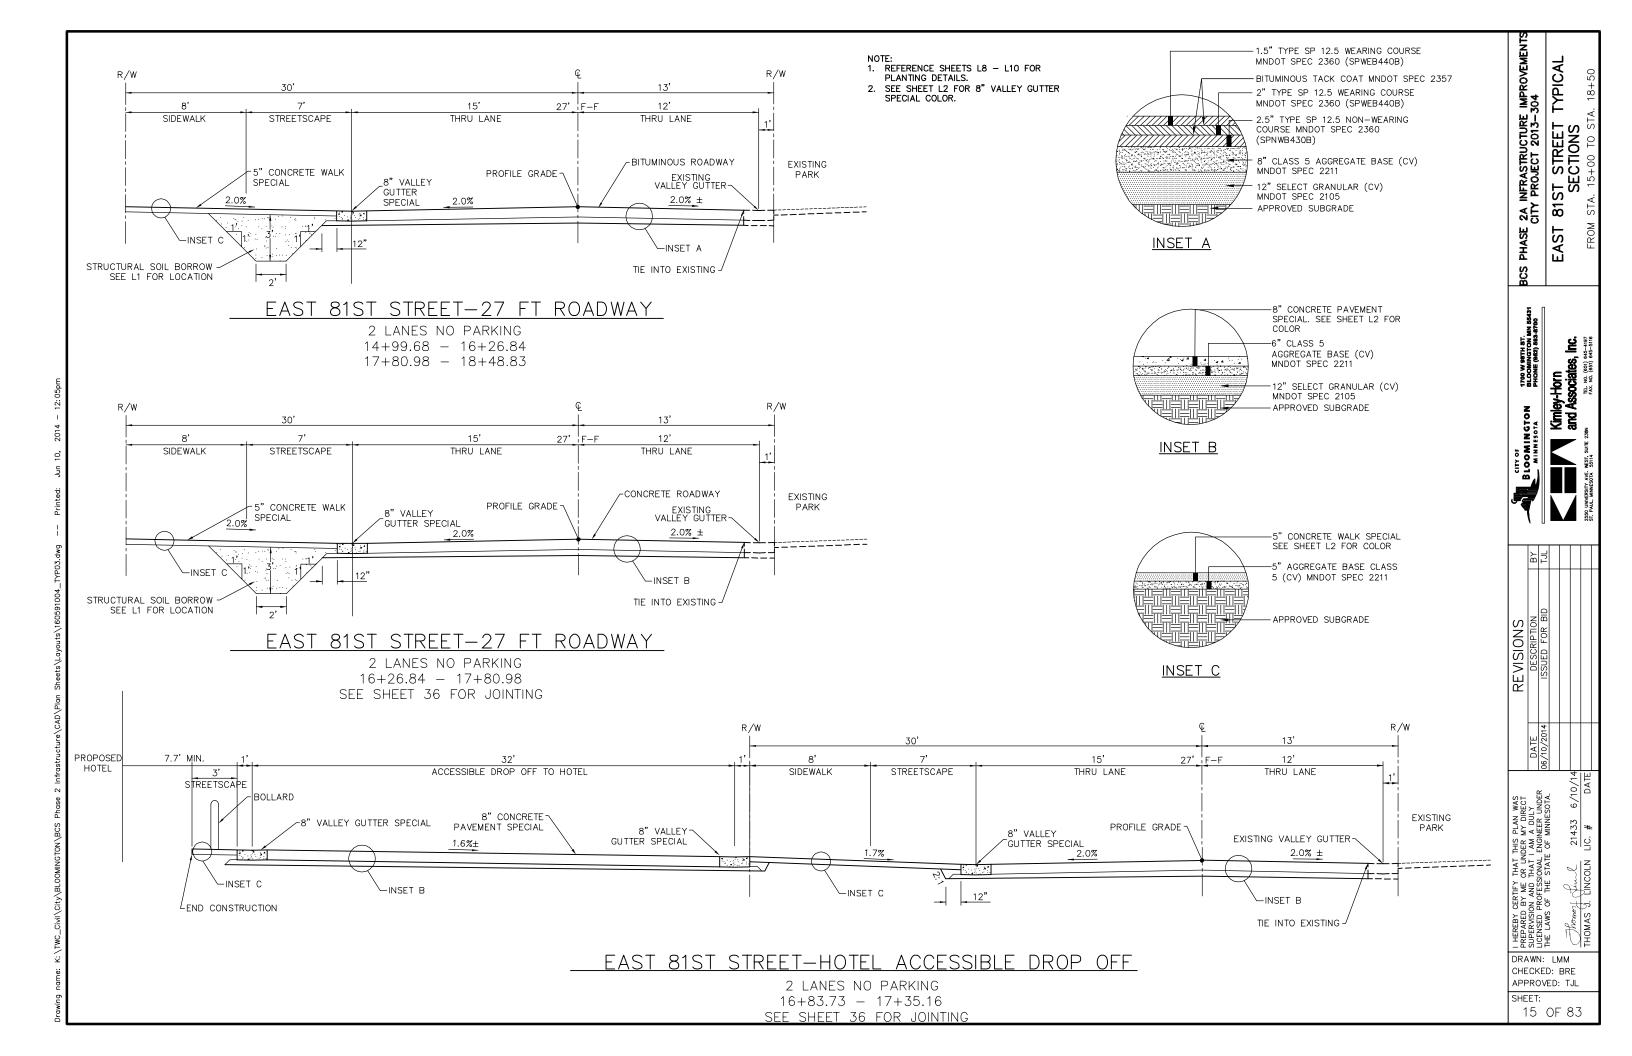

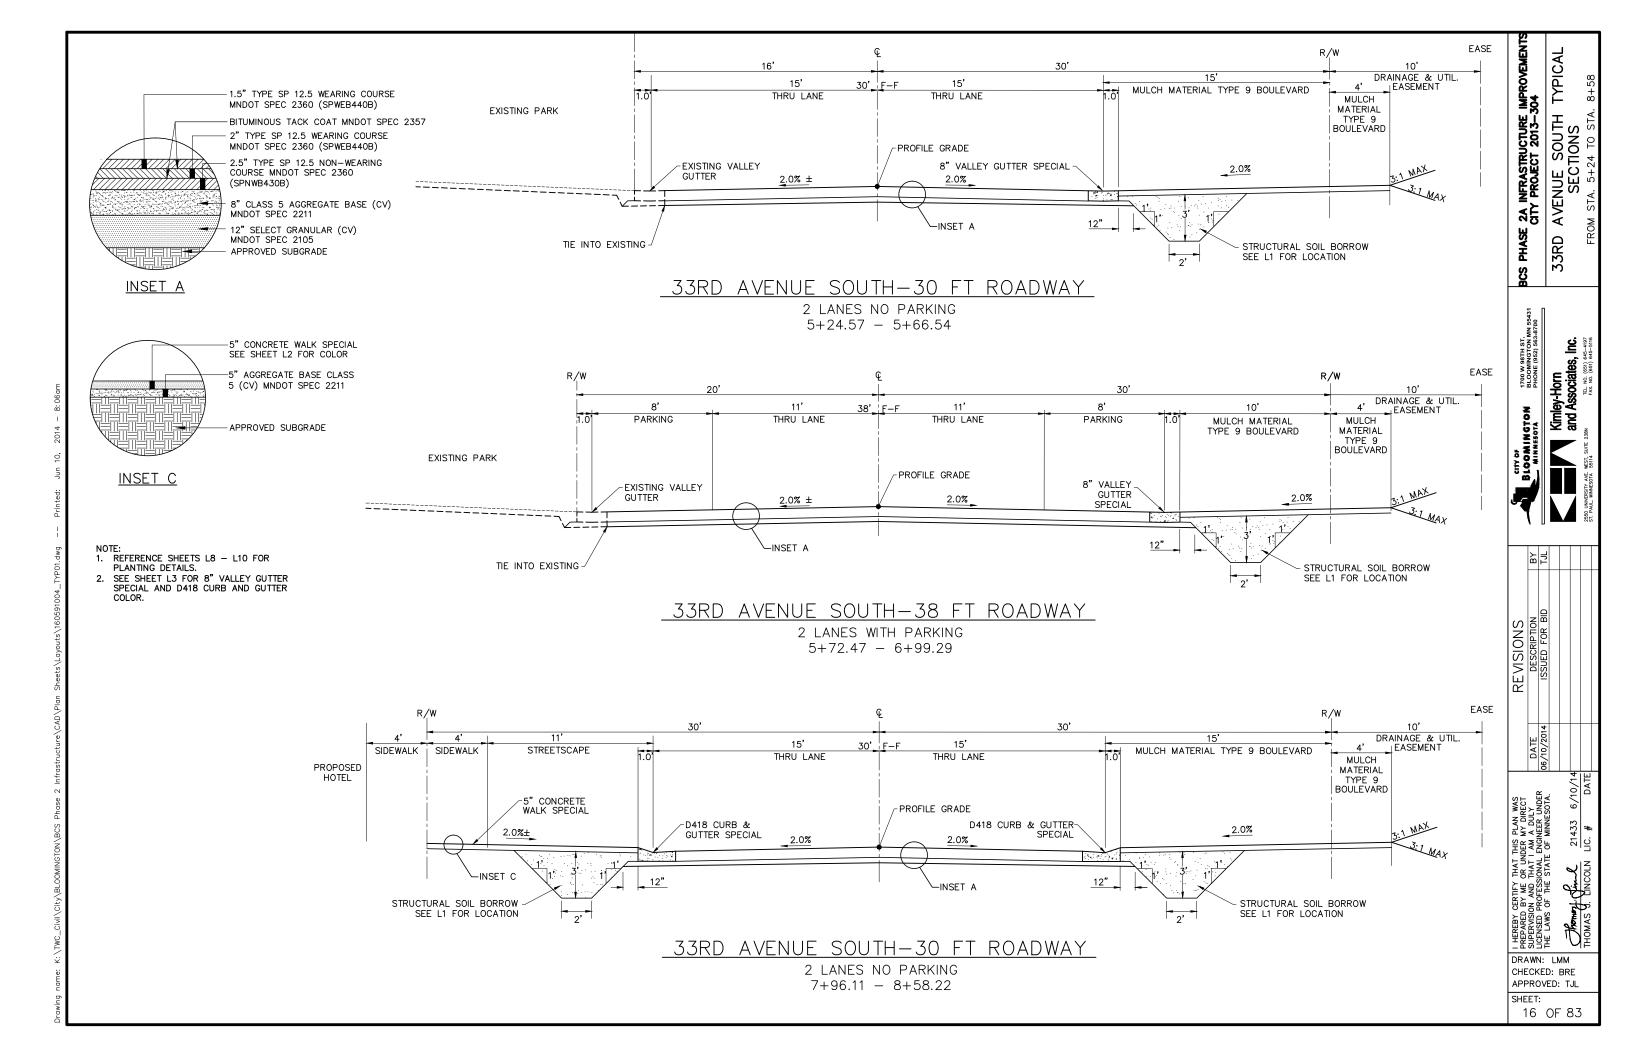
33RD AVENUE SOUTH-38 FT ROADWAY

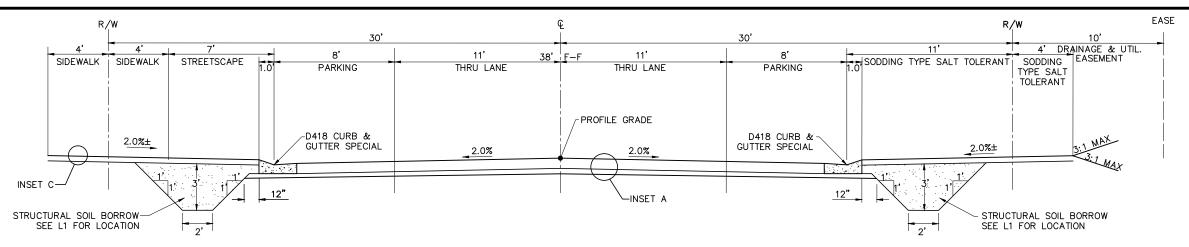2 LANES WITH PARKING STATION 9+79.10 - 10+42.66

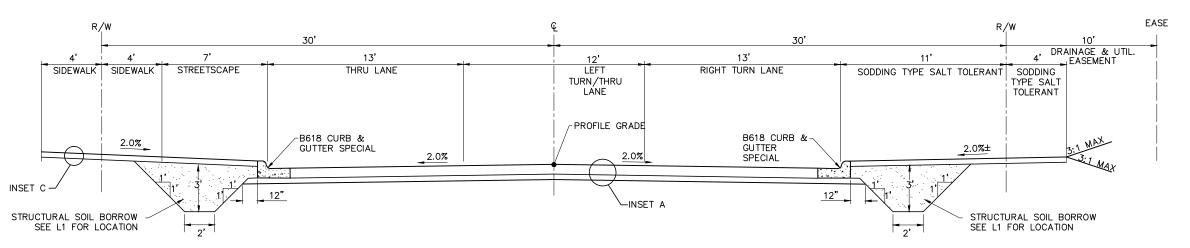

33RD AVENUE SOUTH-38 FT ROADWAY

2 LANES NO PARKING STATION 11+41.31 - 12+73.99

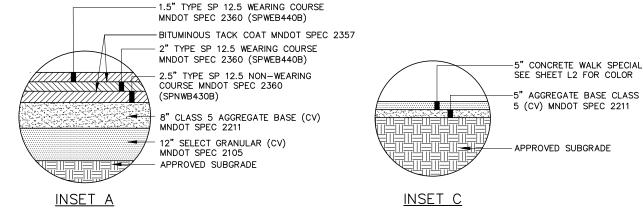

NOTE:

- 1. REFERENCE SHEETS L8 L10 FOR
- PLANTING DETAILS.

 2. SEE SHEET L4 FOR D418 AND B618 CURB AND GUTTER COLOR.

REVISIONS
DESCRIPTION
ISSUED FOR BID I HEREBY CERTIFY THAT THIS PLAN WAS PREPARED BY ME OR UNDER MY DIRECT SUPERVISION AND THAT I AM A DULY ILICENSED PROFESSIONAL ENGINEER UNDER THE LAWS OF THE STATE OF MINNESOTA. 21433 LIC. # DRAWN: LMM CHECKED: BRE APPROVED: TJL SHEET: 17 OF 83


PHASE 2A INFRASTRUCTURE IMPROVEMENTS CITY PROJECT 2013-304

SS

1700 W 98TH ST. BLOOMINGTON MN 55431 PHONE (952) 563-8700 **TYPICAL**

AVENUE SOUTH SECTIONS
OM STA. 9+79 TO STA. 9

33RD

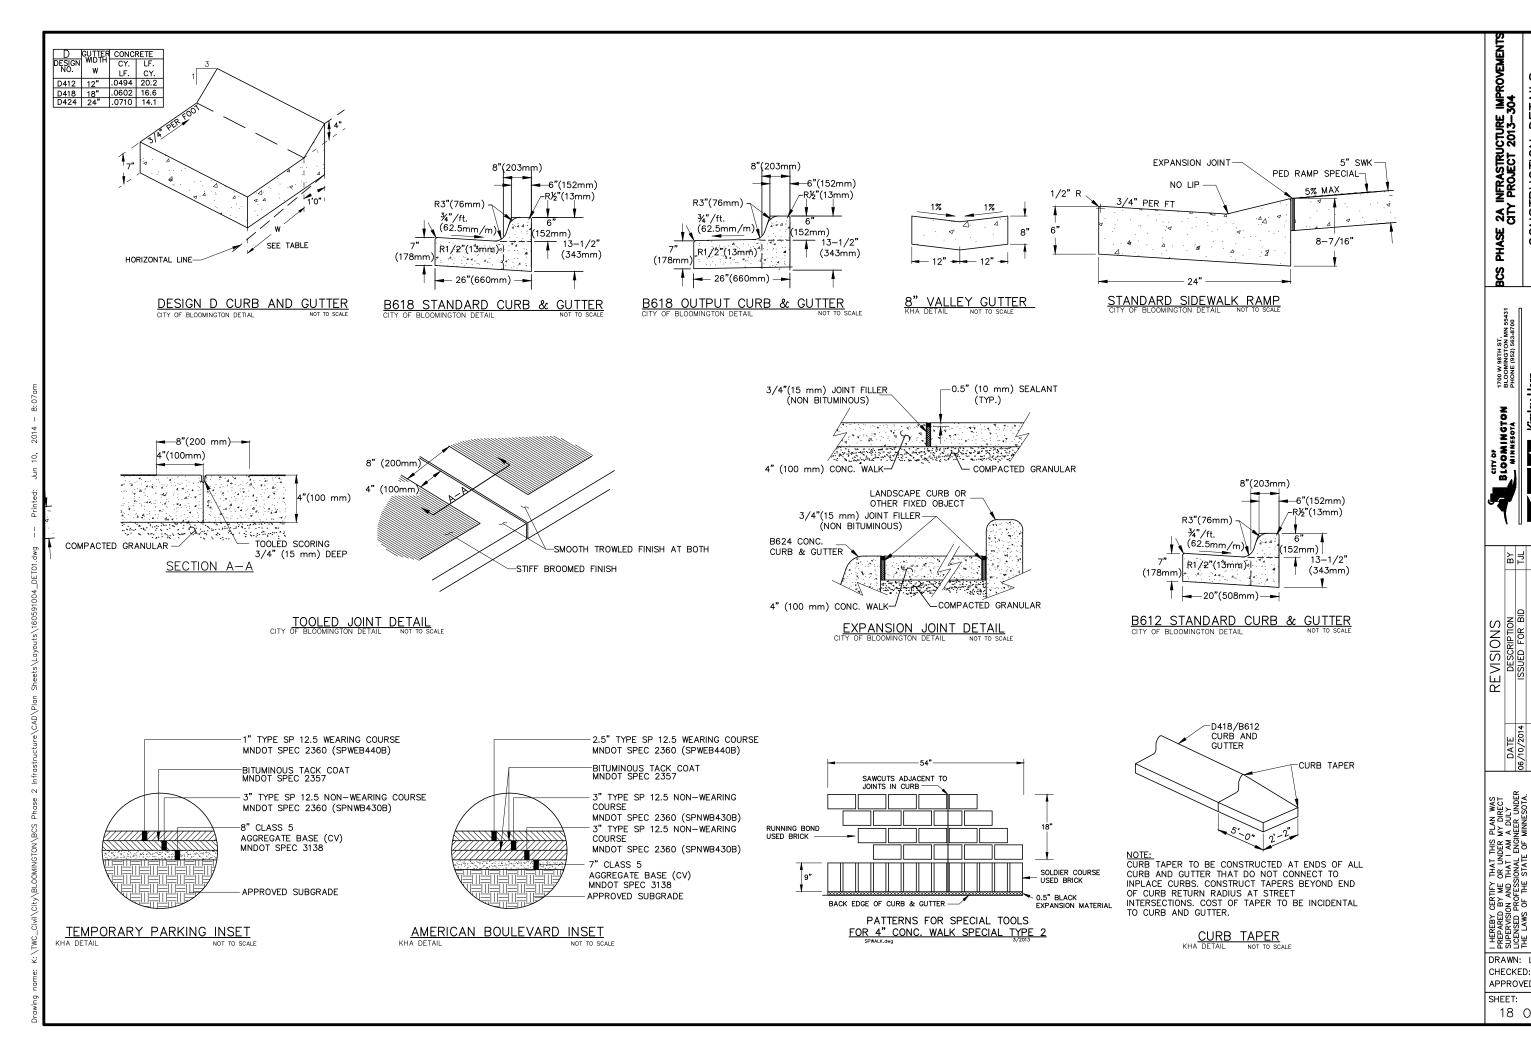

21433 LIC. #

6/10/

DRAWN: LMM CHECKED: BRE APPROVED: TJL

SHEET:

I HEREBY CERTIFY THAT THIS PLAN WAS PREPARED BY ME OR UNDER MY DIRECT SUPERVISION AND THAT I AM A DULY ILICENSED PROFESSIONAL ENGINEER UNDER THE LAWS OF THE STATE OF MINNESOTA.

2A INFRASTRUCTURE IMPROVEMEN' CITY PROJECT 2013-304

PHASE


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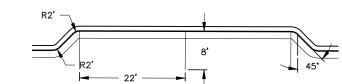
1700 W 98TH ST. BLOOMINGTON MN 55431 PHONE (952) 563-8700

BLOOMINGTON

CONSTRUCTION DETAIL STREET

PEDESTRIAN RAMP DETAILS



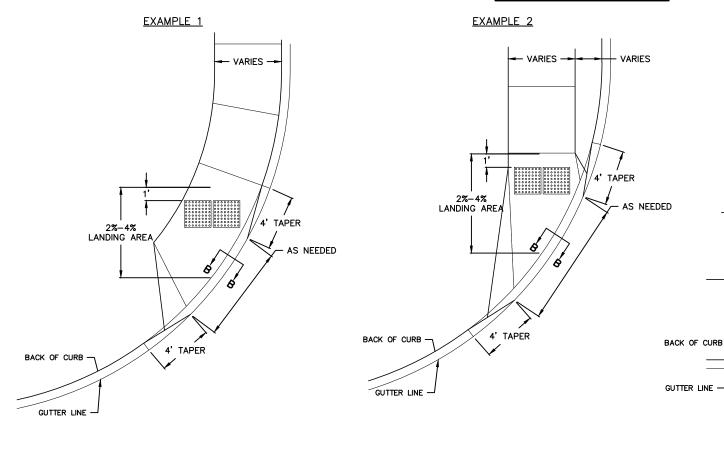


PARALLEL PARKING

KHA DETAIL

NOTES:

- 1. TRUNCATED DOME AREA SHALL BE A NEENAH R-4984 DETECTABLE WARNING PLATE OR APPROVED EQUAL.
- 2. THE COLOR OF THE PLATE SHALL BE CAST IRON NATURAL FINISH OR APPROVED EQUAL.
- 3. THE ENGINEER MAY MODIFY THE GEOMETRICS OF THE RAMP AS NECESSARY TO MATCH EXISTING CONDITIONS, AVOID OBSTRUCTIONS OR FOR OTHER REASONS. NO ADDITIONAL COMPENSATION WILL BE PROVIDED FOR THESE
- 4. THE PLATES ARE AVAILABLE IN RADIUS SECTIONS AND THIS IS PREFERRED IN CURVED SITUATIONS. IF AN APPROPRIATE SIZED RADIUS IS NOT AVAILABLE, THE PLATE SHALL BE SET BACK 4" FROM THE BACK OF CURB.
- 5. WHEN POSSIBLE, PROVIDE A PATH OF TRAVEL 4'0" WIDE BEHIND THE PEDESTRIAN RAMP, A RELATIVELY FLAT 4'X4' LANDING WILL ALLOW WHEELCHAIRS TO NAVIGATE AROUND THE PEDESTRIAN RAMP.
- 6. WHEN A MEDIAN IS NOT WIDE ENOUGH FOR TWO PEDESTRIAN RAMPS AND A 48" LANDING BETWEEN THEM, THE PEDESTRIAN CROSSING SHALL BE CUT THROUGH THE MEDIAN AT STREET LEVEL.
- 7. THE UNIT PRICE FOR PEDESTRIAN RAMP (REGARDLESS OF STYLE) WILL INCLUDE THE TRUNCATED DOME PLATE(S) AND THE IMMEDIATELY SURROUNDING 5" CONCRETE. PEDESTRIAN RAMPS WILL BE PAID AS 'EACH'. THE ESTIMATED SIZE OF THE PAYABLE AREA SHALL BE 21 SQUARE FEET.
- 8. WET CONCRETE MUST BE KEPT OFF THE TOP SURFACE OF THE PLATE AT ALL TIMES.
- 9. THE OVERALL TREAD PATTERN SHALL BE INSTALLED TO BE PARALLEL TO THE INTENDED PEDESTRIAN DIRECTION
- 10. THE LAYOUTS SHOWN ABOVE ARE FOR GENERAL INFORMATION. ACTUAL LAYOUTS CAN BE FOUND BY REFERENCING THE "ACCESSIBLE PUBLIC RIGHTS-OF-WAY: PLANNING AND DESIGNING FOR ALTERATIONS" PUBLISHED BY THE PUBLIC RIGHTS-OF-WAY ACCESS ADVISORY COMMITTEE (DATED JULY 2007).

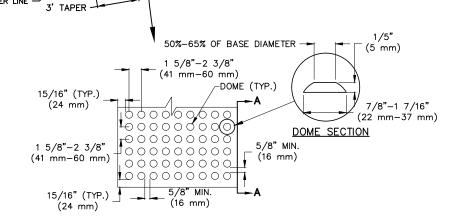

2' TAPER


EXAMPLE 3

- VARIES


3' TAPER

- VARIES -

2%-4% T LANDING AREA

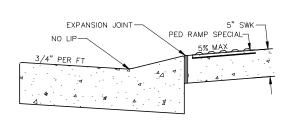

SECTION B-B

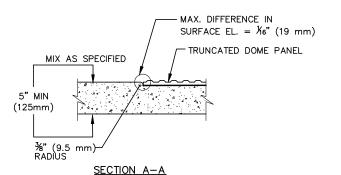

2A INFRASTRUCTURE IMPROVEMEN'S CITY PROJECT 2013-304 DE. STREET CONSTRUCTION PHASE BCS


1700 W 98TH ST BLOOMINGTON MN 55431 PHONE (952) 563-8700

REVISIONS
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Y THAT THIS PLAN WAS E OR UNDER MY DIRECT D THAT I AM A DULY SSIONAL ENGINEER UNDER E STATE OF MINNESOTA. 21433 LIC. #

DRAWN: LMM CHECKED: BRE APPROVED: TJL

SHEET:

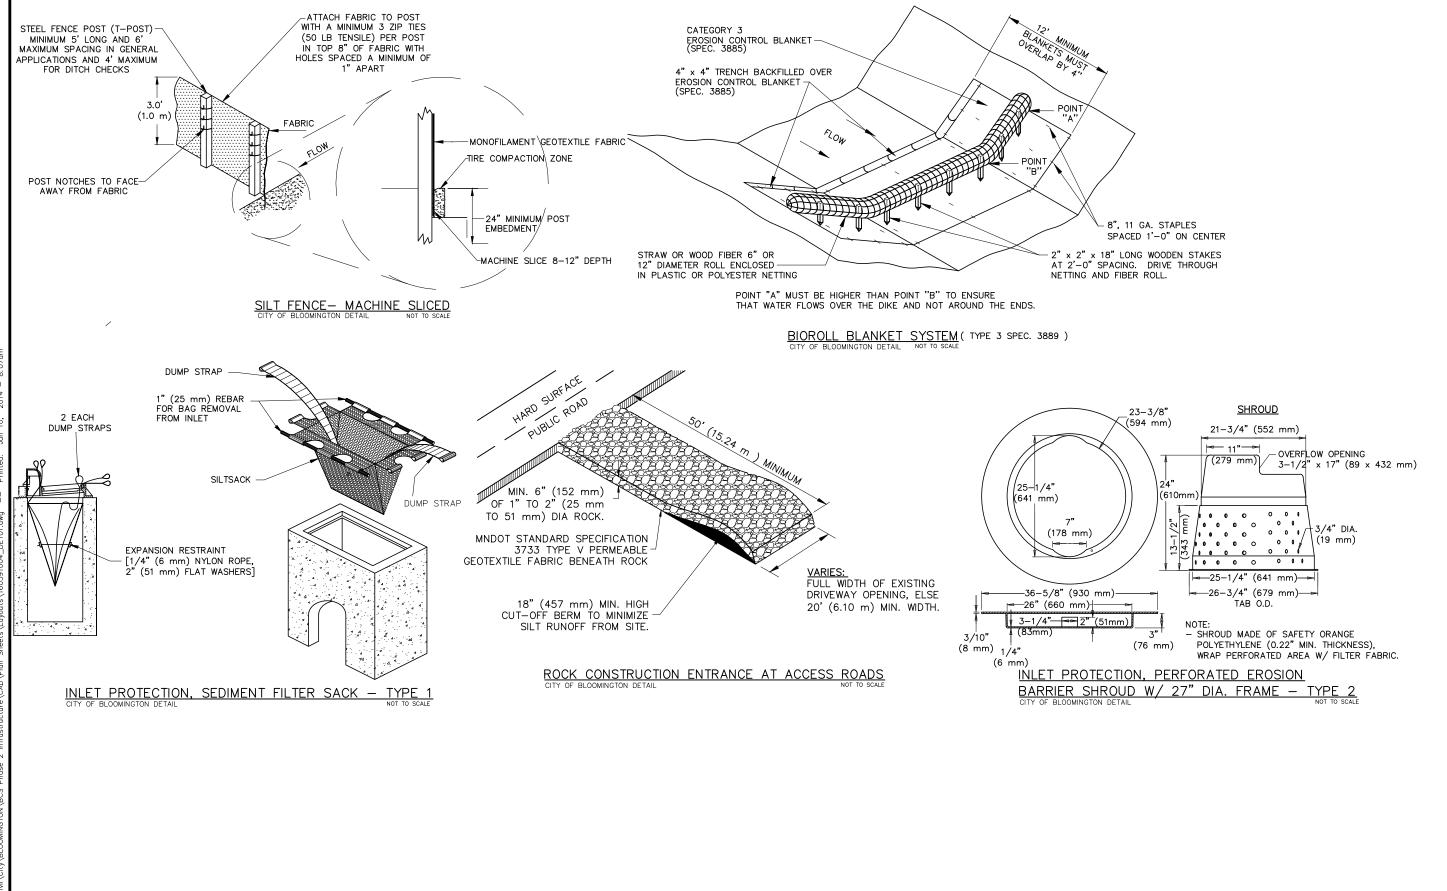

PHASE 2A INFRASTRUCTURE IMPROVEMEN' CITY PROJECT 2013—304 CONSTRUCTION DETAILS EROSION CONTROL

BCS

1700 W 98TH ST. BLOOMINGTON MN 55431 PHONE (952) 563-8700

BLOOMINGTON


REVISIONS
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ISSUED FOR BID

I HEREBY CERTIFY THAT THIS PLAN WAS PREPARED BY ME OR UNDER MY DIRECT SUPERVISION AND THAT I AM A DULY ILICENSED PROFESSIONAL ENGINEER UNDER THE LAWS OF THE STATE OF MINNESOTA. 21433 LIC. #

DRAWN: LMM

CHECKED: BRE APPROVED: TJL

SHEET: 20 OF 83

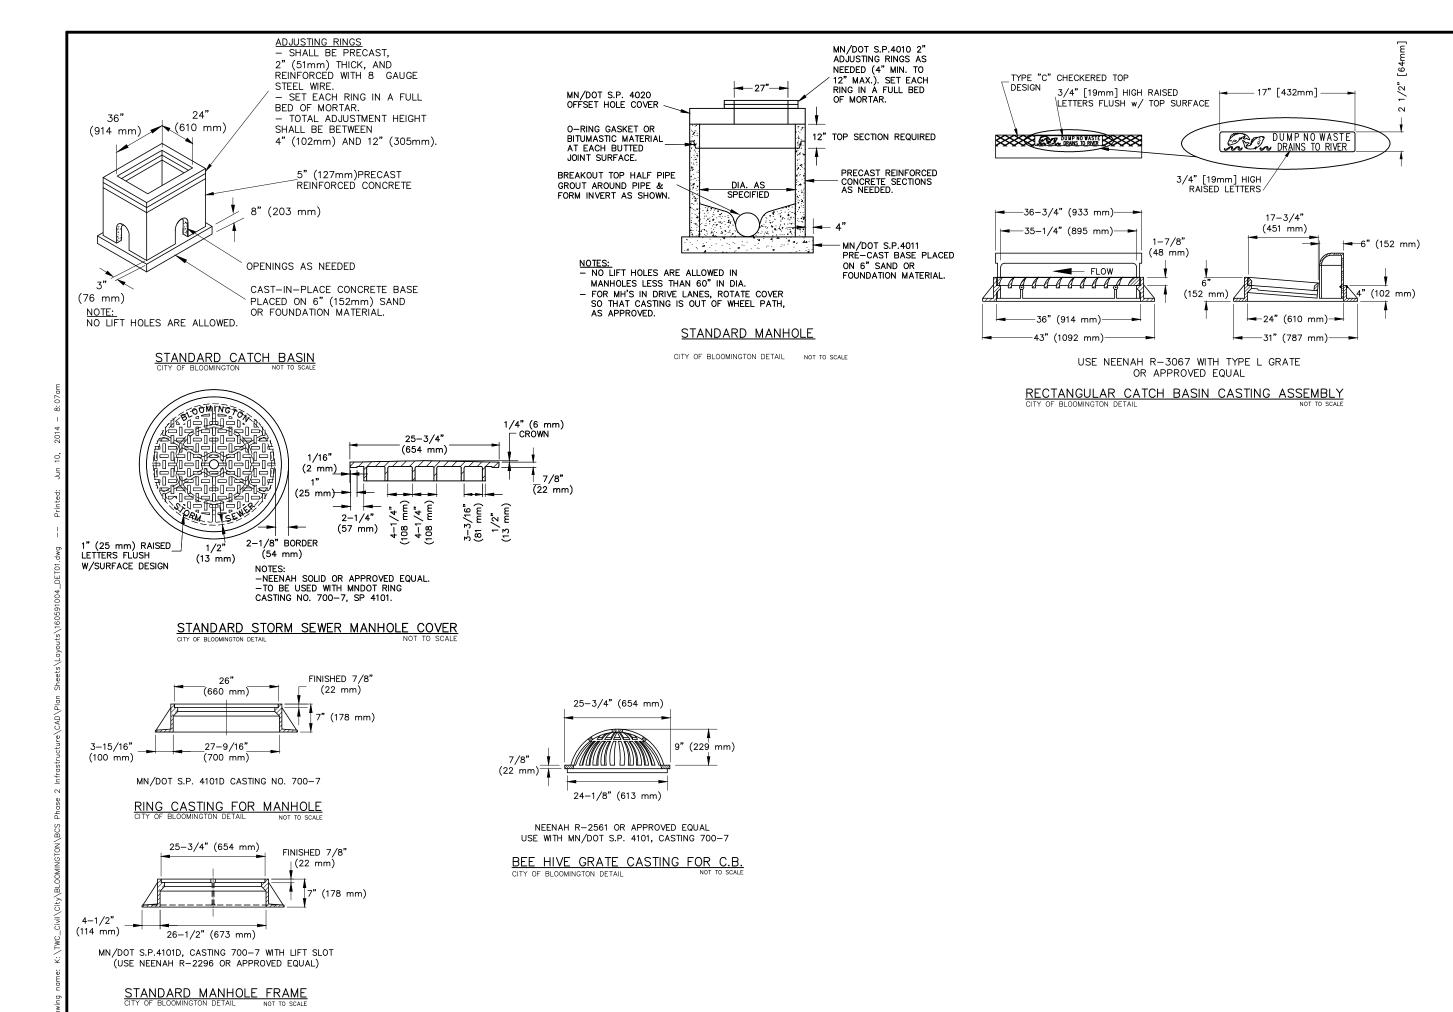

PHASE 24 INFRASTRUCTURE IMPROVEMEN
CITY PROJECT 2013-304
CONSTRUCTION DETAILS
STORM SEWER

1700 W 98TH ST.
BLOOMINGTON MN 55431
PHONE (952) 563-8700

SS


BLOOMINGTON BLOOM
MINNESOTA KIMIBA-Horn
and Associate


HEREBY CERTIFY THAT THIS PLAN WAS PREPARED BY WE OR UNDER MY DIRECT SUPERVISION AND THAT I AM A DULY LICENSED PROFESSIONAL ENGINEER UNDER THE LAWS OF THE STATE OF MINNESOTA.

| Charmal Char 2 21433 6/10, THOMAS Y. ENCOLN IIC. # DA

DRAWN: LMM CHECKED: BRE APPROVED: TJL

SHEET: 21 OF 83

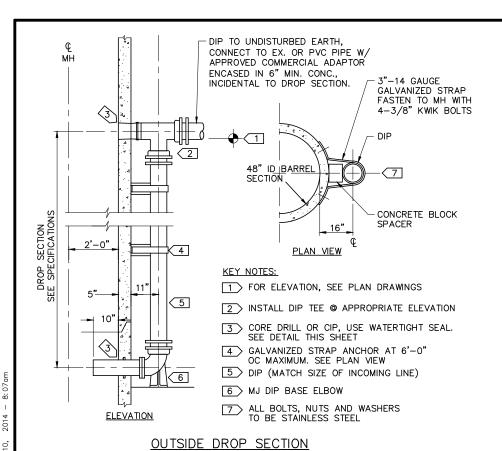

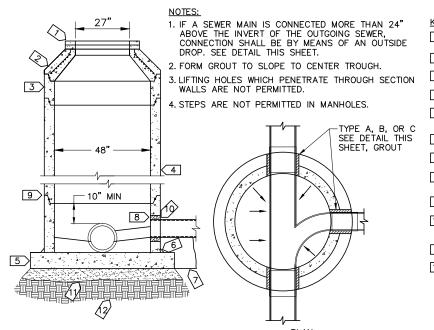

KEY NOTES:

 $\fbox{1}$ MN/DOT S.P.4010 2" ADJUSTING RINGS AS NEEDED [4" MIN. TO 12" MAX.]. SET EACH RING IN FULL BED OF MORTAR.

2 MN/DOT S.P.4010 STD. SHORT CONE SECTION.

3 12" TOP SECTION REQUIRED.

4 USE ONLY PRECAST SECTIONS. NO BRICK OR BLOCK

5>8" CAST IN-PLACE CONCRETE OR 6" PRECAST REINFORCED CONCRETE (64" MINIMUM OD)

6 CEMENT MORTAR ALL AROUND

7 LEAN CONCRETE TO BEAR AGAINST FIRM UNDISTURBED SOIL

8 PROVIDE WATER TIGHT PIPE CONNECTIONS SEE DETAIL THIS SHEET


9 O-RING GASKET


 $\fbox{10}$ For connection to existing MH's, core drill opening and provide type B water tight connector

11 6" SAND OR FOUNDATION MATERIAL

12 UNDISTURBED SOIL OR COMPACTED SUBGRADE

STD. SANITARY SEWER MH

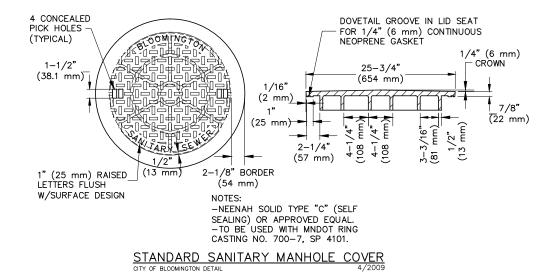

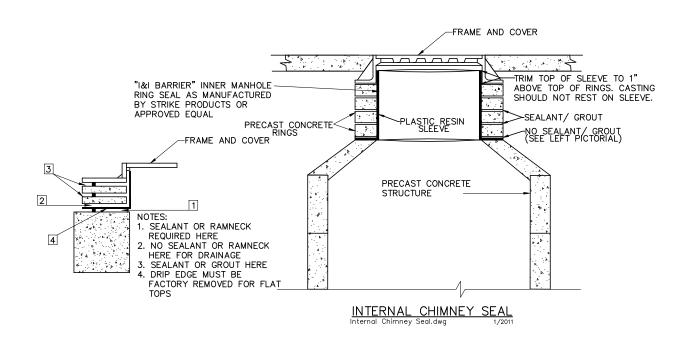

2A INFRASTRUCTURE IMPROVEMENT CITY PROJECT 2013-304 DE CONSTRUCTION DE SANITARY PHASE BCS 1700 W 98TH ST. BLOOMINGTON MN 55431 PHONE (952) 563-8700


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REVISIONS
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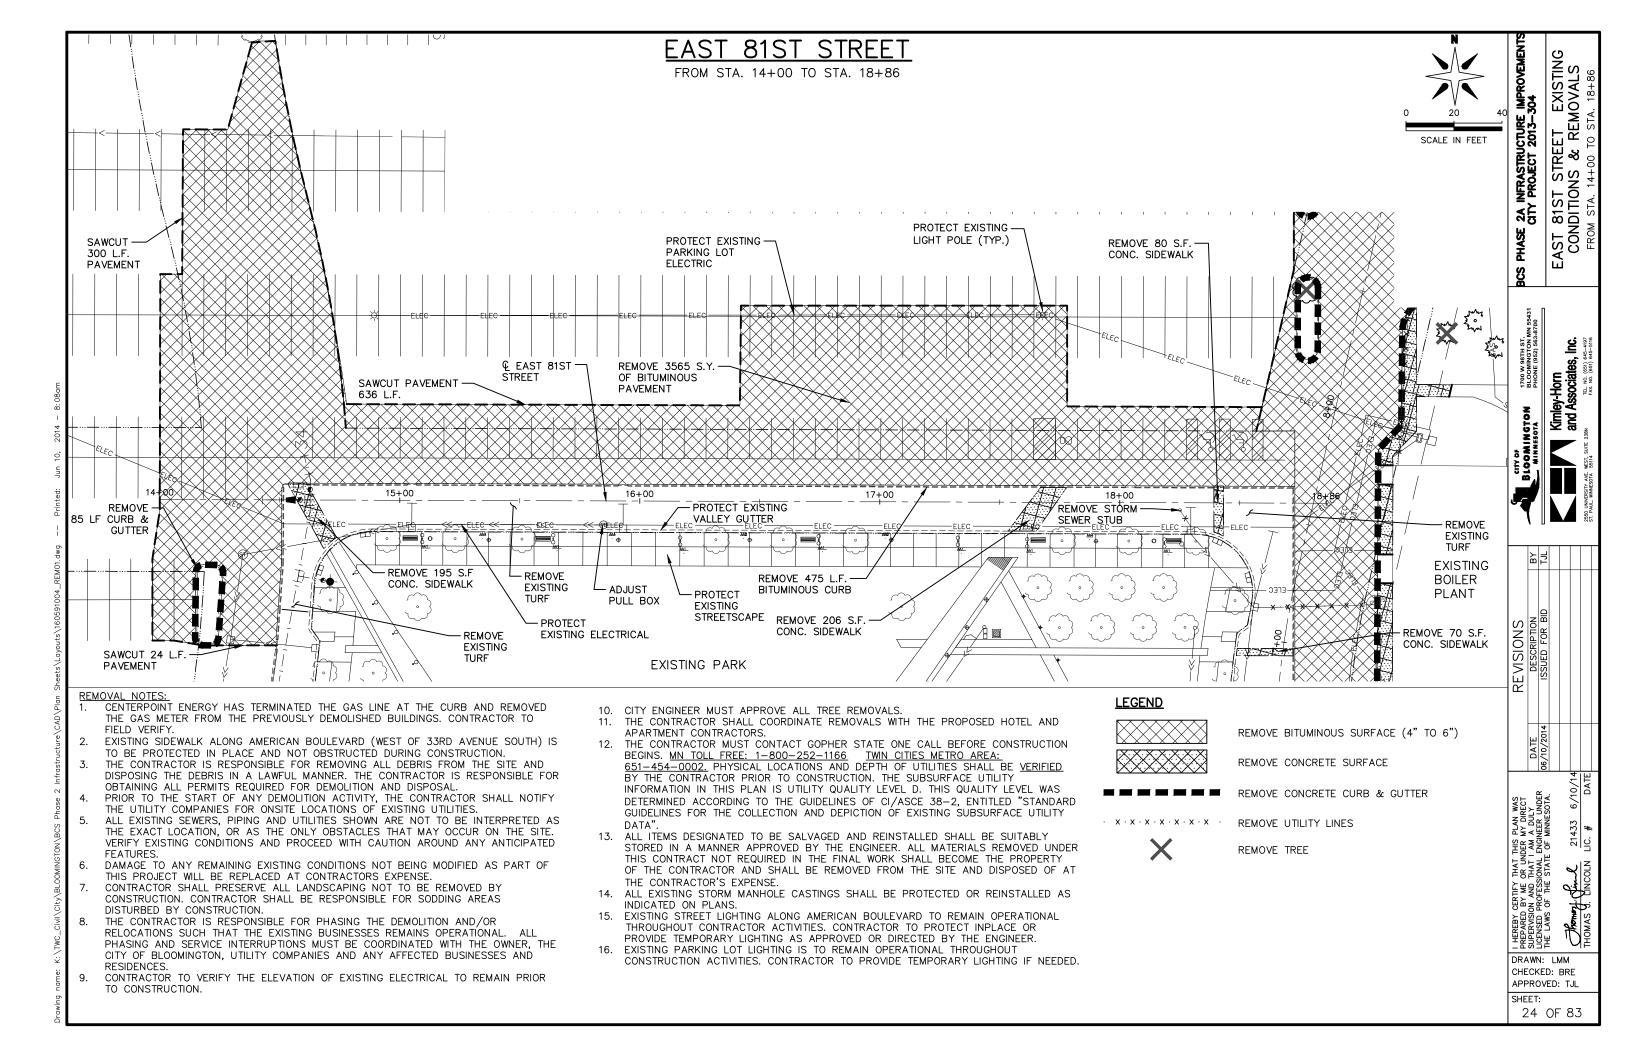
THAT THIS FOR UNDER NOT THAT I AM ASSIONAL ENGINE


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SHEET:



21433



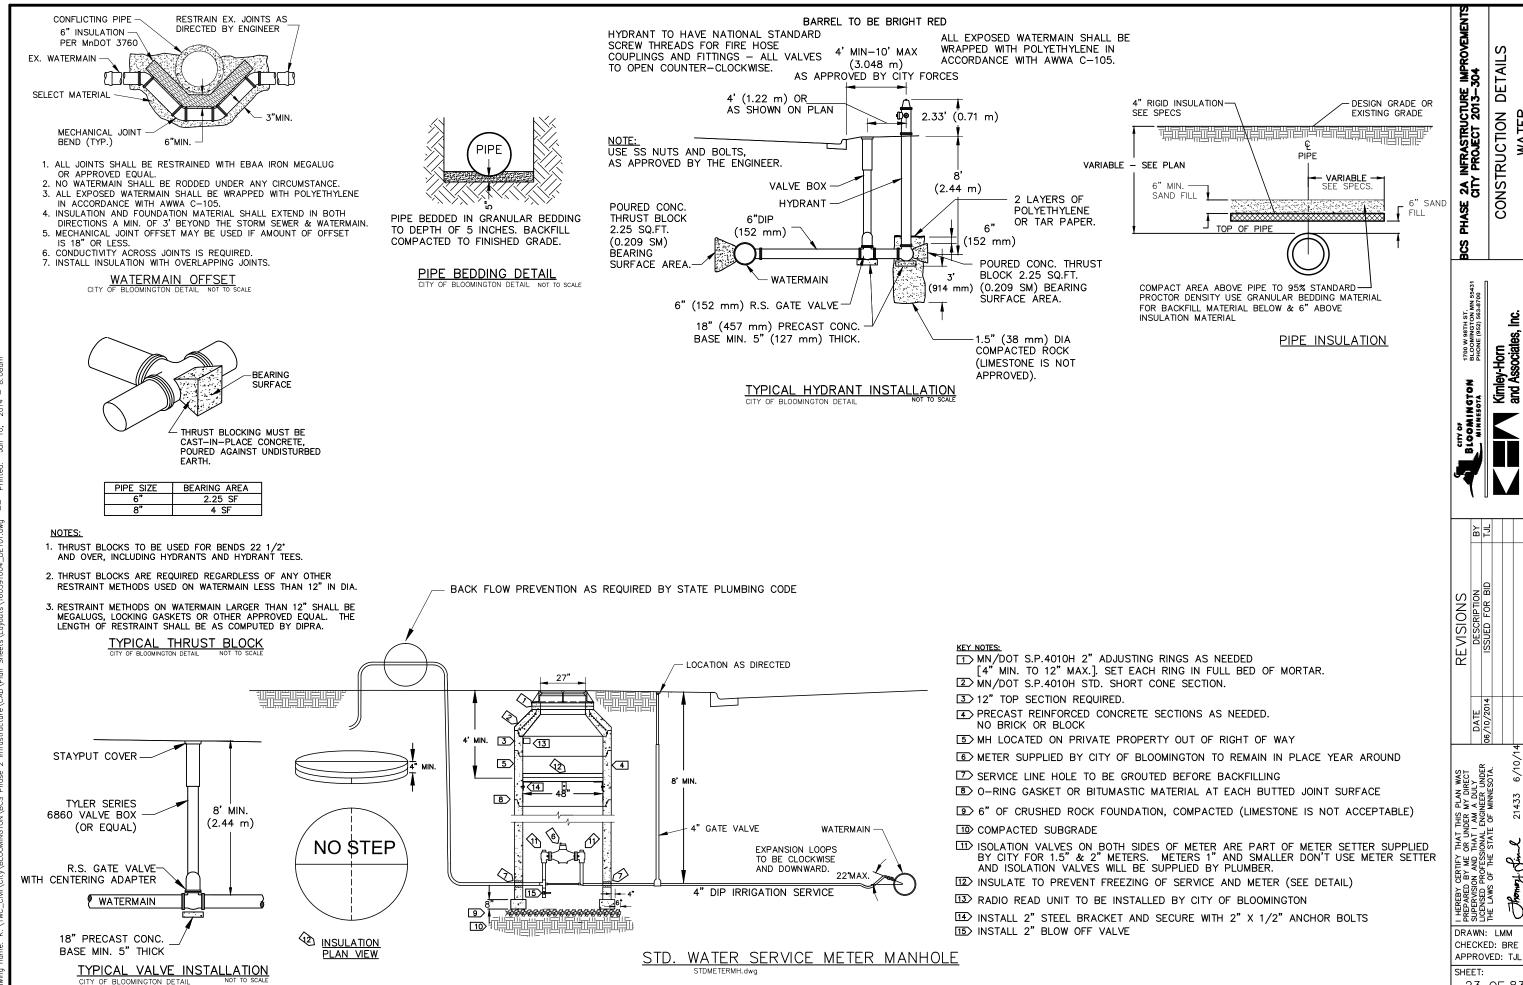

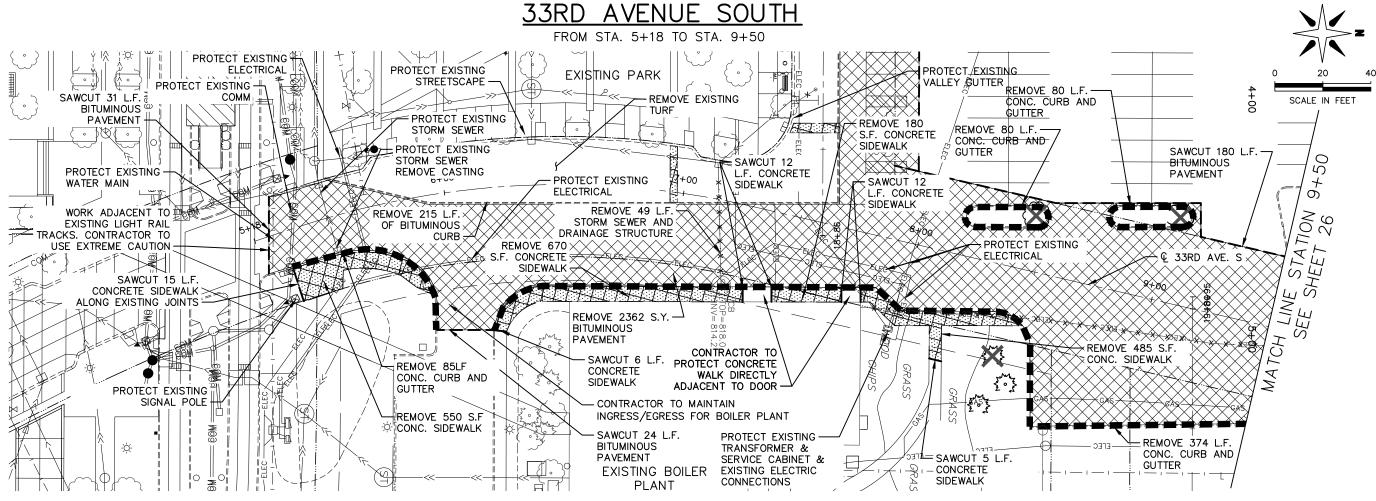REMOVAL NOTES:

1. CENTERPOINT ENERGY HAS TERMINATED THE GAS LINE AT THE CURB AND REMOVED THE GAS METER FROM THE PREVIOUSLY DEMOLISHED BUILDINGS. CONTRACTOR TO FIELD VERIFY.

EXISTING SIDEWALK ALONG AMERICAN BOULEVARD (WEST OF 33RD AVENUE SOUTH) IS
TO BE PROTECTED IN PLACE AND NOT OBSTRUCTED DURING CONSTRUCTION.

3. THE CONTRACTOR IS RESPONSIBLE FOR REMOVING ALL DEBRIS FROM THE SITE AND DISPOSING THE DEBRIS IN A LAWFUL MANNER. THE CONTRACTOR IS RESPONSIBLE FOR OBTAINING ALL PERMITS REQUIRED FOR DEMOLITION AND DISPOSAL.

PRIOR TO THE START OF ANY DEMOLITION ACTIVITY, THE CONTRACTOR SHALL NOTIFY THE UTILITY COMPANIES FOR ONSITE LOCATIONS OF EXISTING UTILITIES.

ALL EXISTING SEWERS, PIPING AND UTILITIES SHOWN ARE NOT TO BE INTERPRETED AS
THE EXACT LOCATION, OR AS THE ONLY OBSTACLES THAT MAY OCCUR ON THE SITE.
VERIFY EXISTING CONDITIONS AND PROCEED WITH CAUTION AROUND ANY ANTICIPATED
FEATURES.

DAMAGE TO ANY REMAINING EXISTING CONDITIONS NOT BEING MODIFIED AS PART OF THIS PROJECT WILL BE REPLACED AT CONTRACTORS EXPENSE.

 CONTRACTOR SHALL PRESERVE ALL LANDSCAPING NOT TO BE REMOVED BY CONSTRUCTION. CONTRACTOR SHALL BE RESPONSIBLE FOR SODDING AREAS DISTURBED BY CONSTRUCTION.

8. THE CONTRACTOR IS RESPONSIBLE FOR PHASING THE DEMOLITION AND/OR RELOCATIONS SUCH THAT THE EXISTING BUSINESSES REMAINS OPERATIONAL. ALL PHASING AND SERVICE INTERRUPTIONS MUST BE COORDINATED WITH THE OWNER, THE CITY OF BLOOMINGTON, UTILITY COMPANIES AND ANY AFFECTED BUSINESSES AND RESIDENCES.

 CONTRACTOR TO VERIFY THE ELEVATION OF EXISTING ELECTRICAL TO REMAIN PRIOR TO CONSTRUCTION. 10. CITY ENGINEER MUST APPROVE ALL TREE REMOVALS.

 THE CONTRACTOR SHALL COORDINATE REMOVALS WITH THE PROPOSED HOTEL AND APARTMENT CONTRACTORS.


THE CONTRACTOR MUST CONTACT GOPHER STATE ONE CALL BEFORE CONSTRUCTION BEGINS. MN TOLL FREE: 1-800-252-1166 TWN CITIES METRO AREA: 651-454-0002. PHYSICAL LOCATIONS AND DEPTH OF UTILITIES SHALL BE VERIFIED BY THE CONTRACTOR PRIOR TO CONSTRUCTION. THE SUBSURFACE UTILITY INFORMATION IN THIS PLAN IS UTILITY QUALITY LEVEL D. THIS QUALITY LEVEL WAS DETERMINED ACCORDING TO THE GUIDELINES OF CI/ASCE 38-2, ENTITLED "STANDARD GUIDELINES FOR THE COLLECTION AND DEPICTION OF EXISTING SUBSURFACE UTILITY DATA".

13. ALL ITEMS DESIGNATED TO BE SALVAGED AND REINSTALLED SHALL BE SUITABLY STORED IN A MANNER APPROVED BY THE ENGINEER. ALL MATERIALS REMOVED UNDER THIS CONTRACT NOT REQUIRED IN THE FINAL WORK SHALL BECOME THE PROPERTY OF THE CONTRACTOR AND SHALL BE REMOVED FROM THE SITE AND DISPOSED OF AT THE CONTRACTOR'S EXPENSE.

4. ALL EXISTING STORM MANHOLE CASTINGS SHALL BE PROTECTED OR REINSTALLED AS INDICATED ON PLANS.

5. EXISTING STREET LIGHTING ALONG AMERICAN BOULEVARD TO REMAIN OPERATIONAL THROUGHOUT CONTRACTOR ACTIVITIES. CONTRACTOR TO PROTECT INPLACE OR PROVIDE TEMPORARY LIGHTING AS APPROVED OR DIRECTED BY THE ENGINEER.

 EXISTING PARKING LOT LIGHTING IS TO REMAIN OPERATIONAL THROUGHOUT CONSTRUCTION ACTIVITIES. CONTRACTOR TO PROVIDE TEMPORARY LIGHTING IF NEEDED. LEGEND

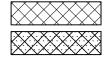

REMOVE BITUMINOUS SURFACE (4" TO 6")

REMOVE CONCRETE SURFACE

REMOVE CONCRETE CURB & GUTTER

X

REMOVE TREE



SOUTH EXISTING
& REMOVALS
18 TO STA 9+50

33RD AVENUE SCONDITIONS FROM STA. 5+11

AZ G∏≺

PHASE

BCS

1700 W 98TH ST. BLOOMINGTON MN 55431 PHONE (952) 563-8700


I HEREBY CERTIFY THAT THIS PLAN WA
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SUPERVISION AND THAT I AM A DULY
LICENSED PROFESSIONAL ENGINEER UN
THE LAWS OF THE STATE OF MINNESO
THOMAS TO THE STATE OF THE S


DRAWN: LMM CHECKED: BRE APPROVED: TJL

SHEET: 25 OF 83

33RD AVENUE SOUTH


FROM STA. 9+50 TO STA. 13+84

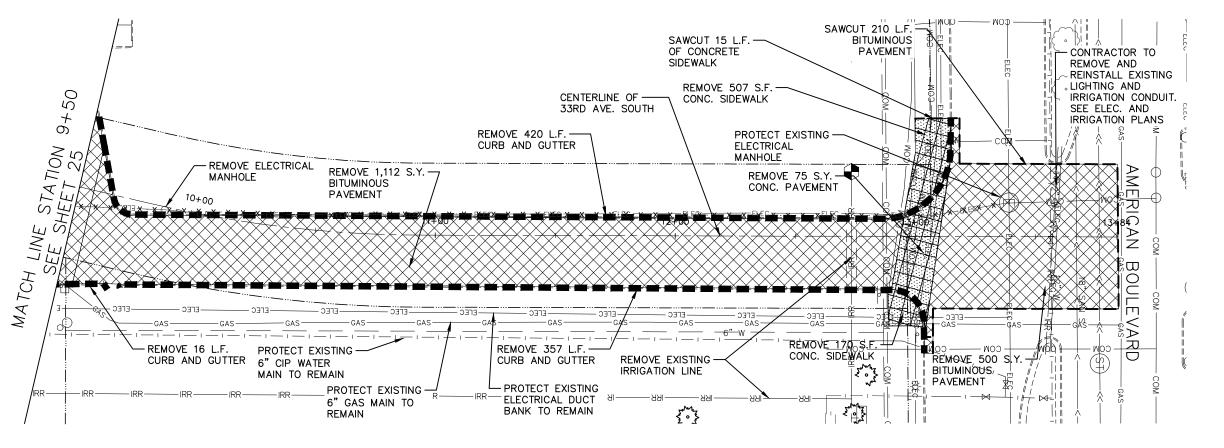

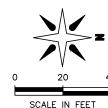

- CENTERPOINT ENERGY HAS TERMINATED THE GAS LINE AT THE CURB AND REMOVED THE GAS METER FROM THE PREVIOUSLY DEMOLISHED BUILDINGS. CONTRACTOR TO
- EXISTING SIDEWALK ALONG AMERICAN BOULEVARD (WEST OF 33RD AVENUE SOUTH) IS TO BE PROTECTED IN PLACE AND NOT OBSTRUCTED DURING CONSTRUCTION.
- THE CONTRACTOR IS RESPONSIBLE FOR REMOVING ALL DEBRIS FROM THE SITE AND DISPOSING THE DEBRIS IN A LAWFUL MANNER. THE CONTRACTOR IS RESPONSIBLE FOR OBTAINING ALL PERMITS REQUIRED FOR DEMOLITION AND DISPOSAL
- PRIOR TO THE START OF ANY DEMOLITION ACTIVITY, THE CONTRACTOR SHALL NOTIFY THE UTILITY COMPANIES FOR ONSITE LOCATIONS OF EXISTING UTILITIES.
- EXISTING SEWERS, PIPING AND UTILITIES SHOWN ARE NOT TO BE INTERPRETED AS THE EXACT LOCATION, OR AS THE ONLY OBSTACLES THAT MAY OCCUR ON THE SITE. VERIFY EXISTING CONDITIONS AND PROCEED WITH CAUTION AROUND ANY ANTICIPATED FEATURES.
- DAMAGE TO ANY REMAINING EXISTING CONDITIONS NOT BEING MODIFIED AS PART OF THIS PROJECT WILL BE REPLACED AT CONTRACTORS EXPENSE.
- CONTRACTOR SHALL PRESERVE ALL LANDSCAPING NOT TO BE REMOVED BY CONSTRUCTION. CONTRACTOR SHALL BE RESPONSIBLE FOR SODDING AREAS DISTURBED BY CONSTRUCTION.
- THE CONTRACTOR IS RESPONSIBLE FOR PHASING THE DEMOLITION AND/OR RELOCATIONS SUCH THAT THE EXISTING BUSINESSES REMAINS OPERATIONAL. PHASING AND SERVICE INTERRUPTIONS MUST BE COORDINATED WITH THE OWNER, THE CITY OF BLOOMINGTON, UTILITY COMPANIES AND ANY AFFECTED BUSINESSES AND RESIDENCES
- CONTRACTOR TO VERIFY THE ELEVATION OF EXISTING ELECTRICAL TO REMAIN PRIOR TO CONSTRUCTION.

- CITY ENGINEER MUST APPROVE ALL TREE REMOVALS.
- THE CONTRACTOR SHALL COORDINATE REMOVALS WITH THE PROPOSED HOTEL AND APARTMENT CONTRACTORS.
- THE CONTRACTOR MUST CONTACT GOPHER STATE ONE CALL BEFORE CONSTRUCTION BEGINS. MN TOLL FREE: 1-800-252-1166 TWIN CITIES METRO AREA: 651-454-0002. PHYSICAL LOCATIONS AND DEPTH OF UTILITIES SHALL BE VERIFIED BY THE CONTRACTOR PRIOR TO CONSTRUCTION. THE SUBSURFACE UTILITY INFORMATION IN THIS PLAN IS UTILITY QUALITY LEVEL D. THIS QUALITY LEVEL WAS DETERMINED ACCORDING TO THE GUIDELINES OF CI/ASCE 38-2, ENTITLED "STANDARD GUIDELINES FOR THE COLLECTION AND DEPICTION OF EXISTING SUBSURFACE UTILITY DATA".
- ALL ITEMS DESIGNATED TO BE SALVAGED AND REINSTALLED SHALL BE SUITABLY STORED IN A MANNER APPROVED BY THE ENGINEER. ALL MATERIALS REMOVED UNDER THIS CONTRACT NOT REQUIRED IN THE FINAL WORK SHALL BECOME THE PROPERTY OF THE CONTRACTOR AND SHALL BE REMOVED FROM THE SITE AND DISPOSED OF AT THE CONTRACTOR'S EXPENSE.
- ALL EXISTING STORM MANHOLE CASTINGS SHALL BE PROTECTED OR REINSTALLED AS INDICATED ON PLANS.
- EXISTING STREET LIGHTING ALONG AMERICAN BOULEVARD TO REMAIN OPERATIONAL THROUGHOUT CONTRACTOR ACTIVITIES. CONTRACTOR TO PROTECT INPLACE OR PROVIDE TEMPORARY LIGHTING AS APPROVED OR DIRECTED BY THE ENGINEER.
- EXISTING PARKING LOT LIGHTING IS TO REMAIN OPERATIONAL THROUGHOUT CONSTRUCTION ACTIVITIES. CONTRACTOR TO PROVIDE TEMPORARY LIGHTING IF NEEDED.

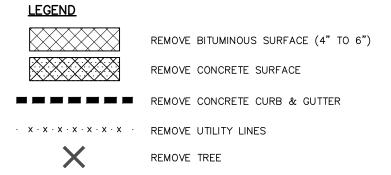

33RD AVENUE SCONDITIONS
FROM STA. 9+50 PHASE BCS 1700 W 98TH ST BLOOMINGTON MN 55431 PHONE (952) 563-8700 BLOOMINGTON REVISION 21433 LIC. # THAT THIS I OR UNDER N THAT I AM SISIONAL ENGIN CERTIFY
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PROFESS
OF THE DRAWN: LMM CHECKED: BRE


APPROVED: TJL

26 OF 83

SHEET:


SOUTH EXISTING
& REMOVALS
10 STA. 13+84

2A INFRASTRUCTURE CITY PROJECT 2013—3

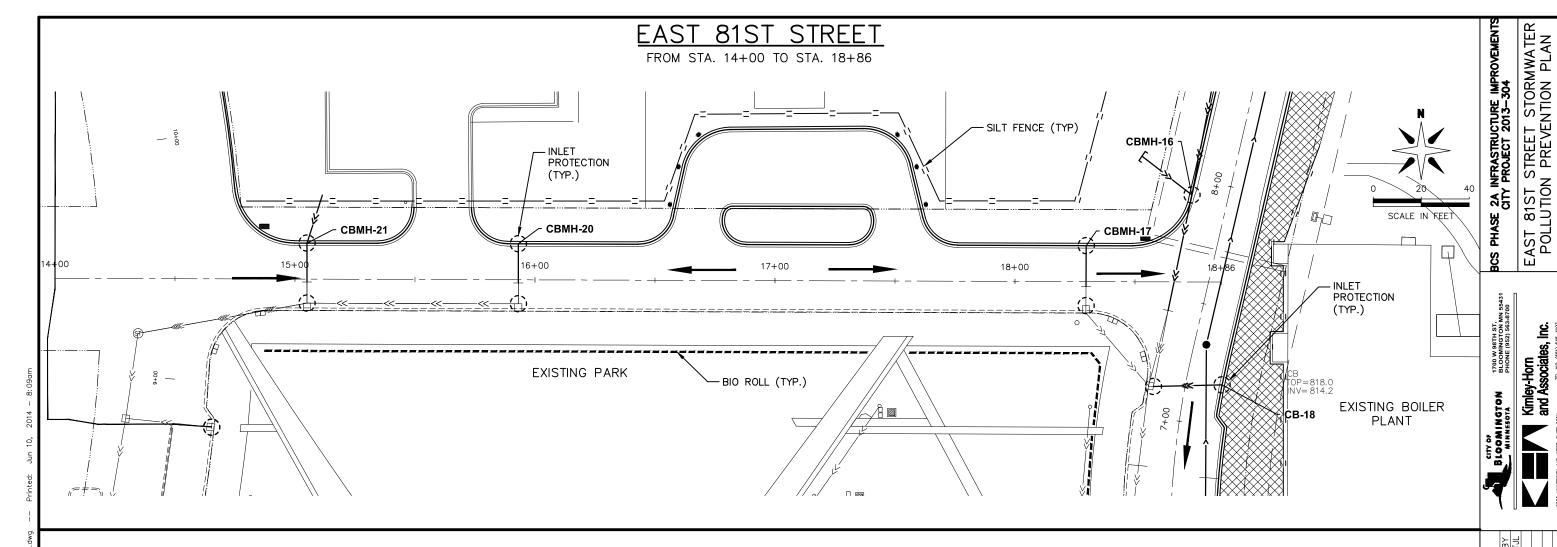

NOTES:


- EROSION CONTROL MUST BE IN-PLACE PRIOR TO REMOVALS. ALL INLETS MUST BE PROTECTED OR PLATED.
- 2. ALL EROSION CONTROL MEASURES SHALL BE MAINTAINED ACCORDING TO THE MINNESOTA POLLUTION CONTROL AGENCY'S BEST MANAGEMENT PRACTICES MANUAL (NOVEMBER 2002).

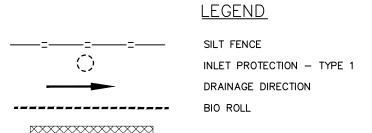



RAPID STABILIZATION METHOD 3

> DRAWN: LMM CHECKED: BRE APPROVED: TJL

SHEET: 27 OF 83

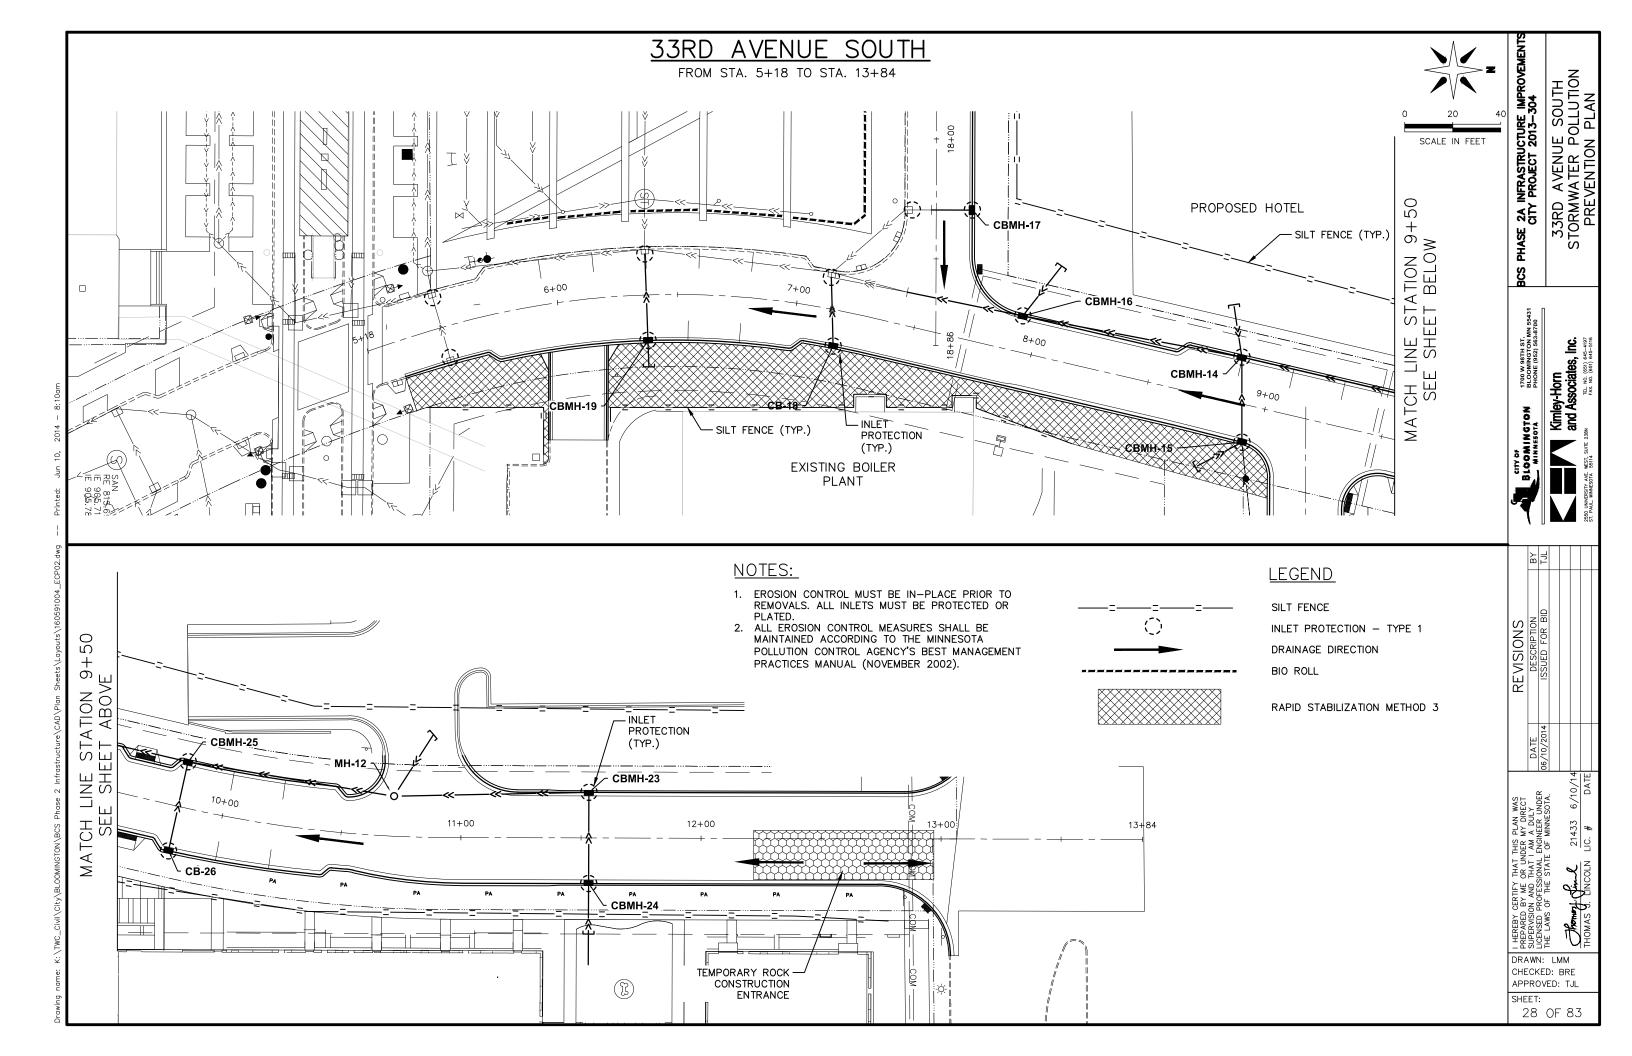

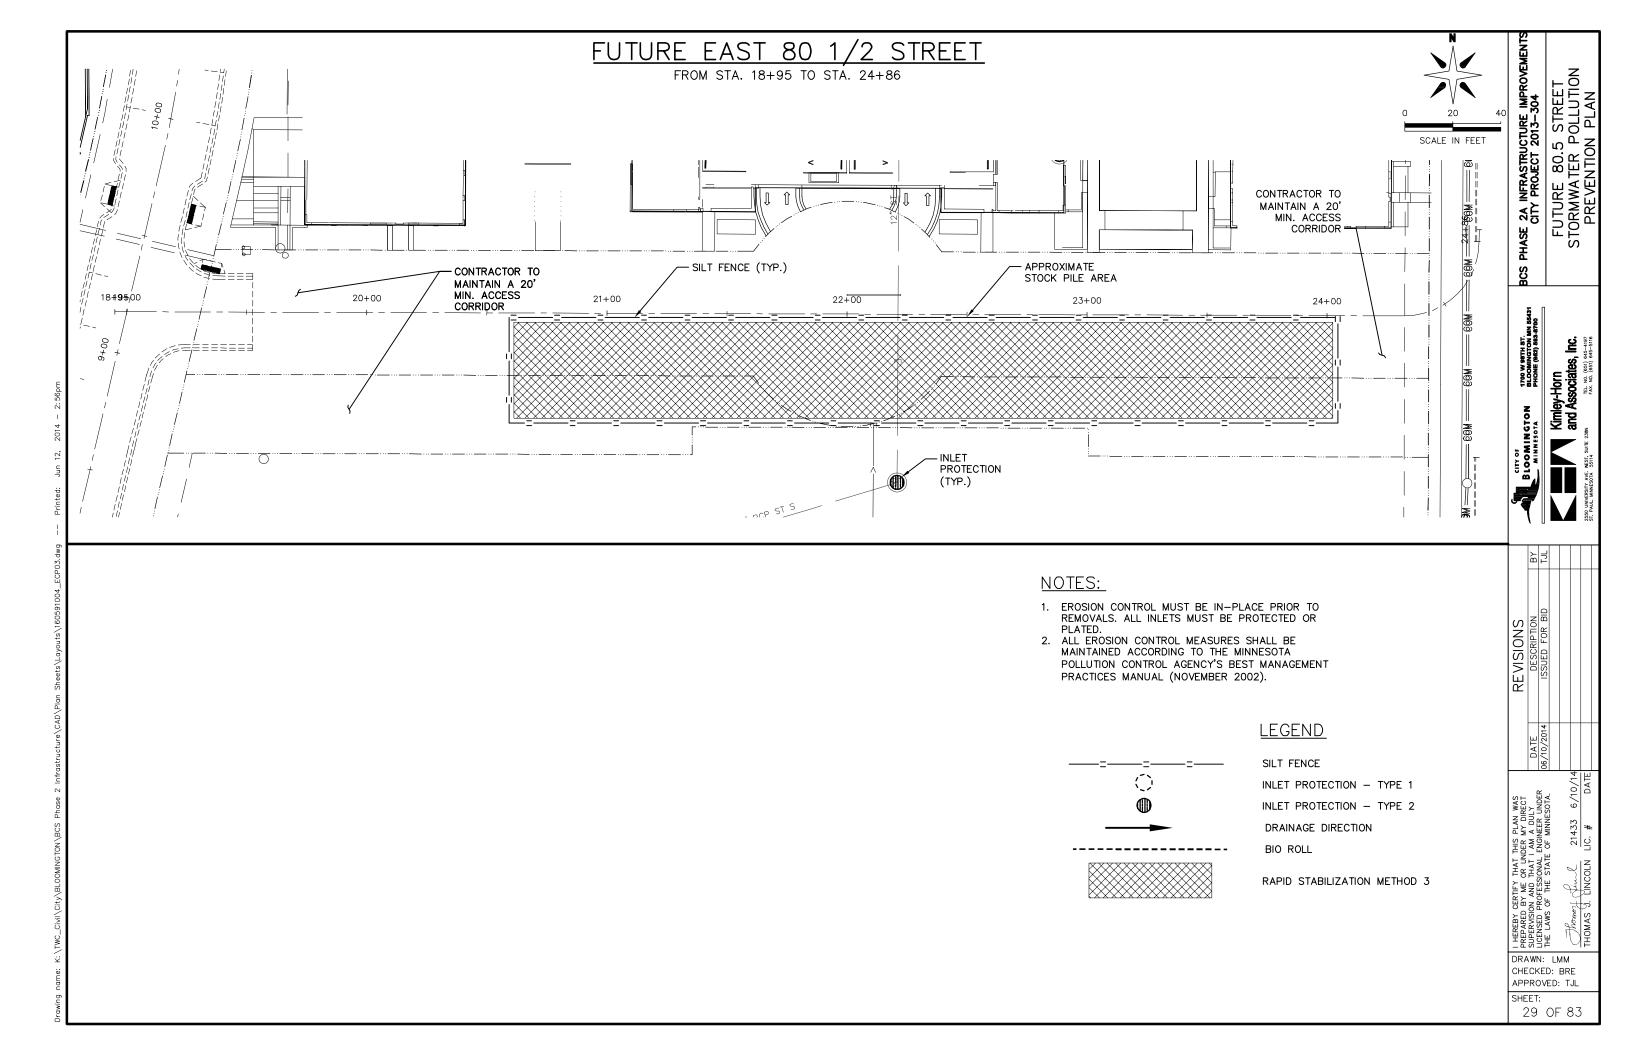

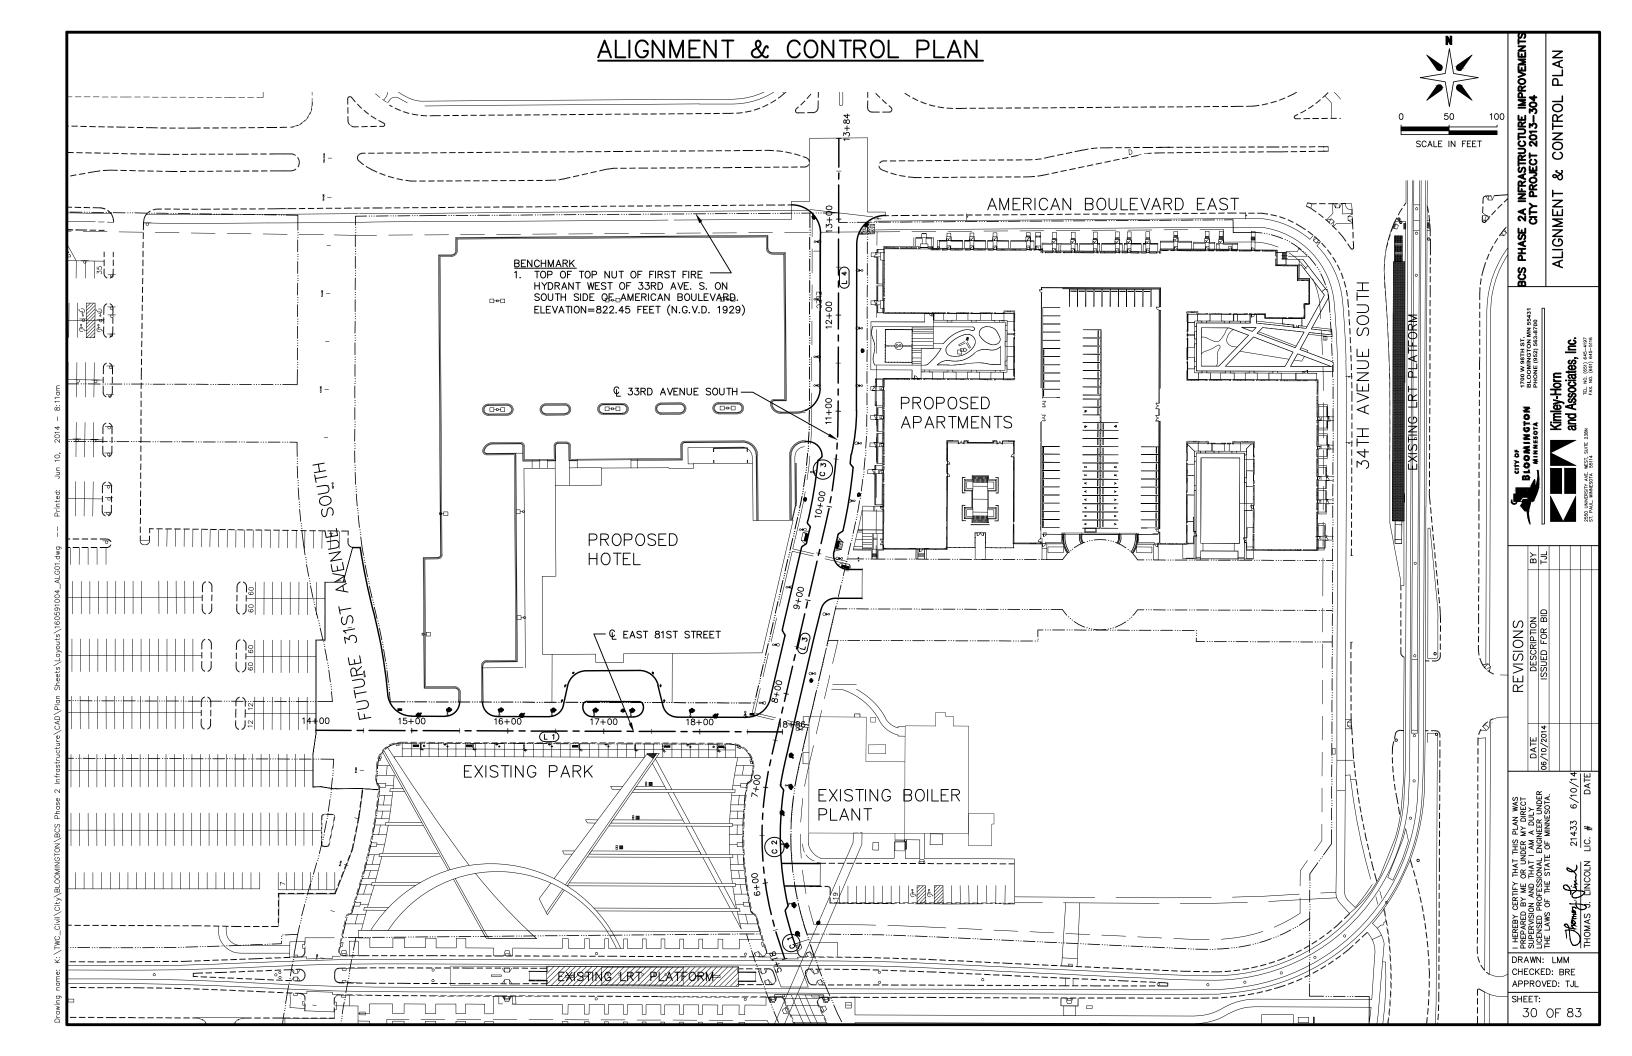

ALIGNMENT & CONTROL PLAN

	ALIGNMENT DATA East 81st Street												
SEGMENT NUMBER			PI STATION	DELTA	DEGREE	RADIUS (FT)	TANGENT (FT)	LENGTH (FT)	BEGINNING COORDINATES NORTHING	BEGINNING COORDINATES EASTING	ENDING COORDINATES NORTHING	ENDING COORDINATES EASTING	AZIMUTH
L 1	14+00.00	18+86.00						486.00	124091.94	540391.30	124090.37	540877.30	90°11'04"

	ALIGNMENT DATA 33rd Avenue South												
SEGMENT NUMBER	BEGINNING STATION	ENDING STATION	PI STATION	DELTA	DEGREE	RADIUS (FT)	TANGENT (FT)	LENGTH (FT)	BEGINNING COORDINATES NORTHING	BEGINNING COORDINATES EASTING	ENDING COORDINATES NORTHING	ENDING COORDINATES EASTING	AZIMUTH
C 1	5+18.32	5+45.51	5+31.91	2*04'37"	7*38'21.97"	750.00	13.59	27.19	123853.76	540879.67	123879.61	540871.27	340°57'48" 343°02'24"
C 2	5+45.51	7+29.19	6+39.52	30°04'11"	16°22'12.80"	350.00	94.01	183.69	123879.61	540871.27	124061.10	540865.17	343°02'24" 13°06'35"
L 3	7+29.19	9+81.02						251.83	124061.10	540865.17	124306.36	540922.29	13*06'35"
С 3	9+81.02	10+94.08	10+37.79	12*57'20"	11*27'32.96"	500.00	56.77	113.06	124306.36	540922.29	124418.42	540935.32	13°06'35" 0°09'15"
L 4	10+94.08	13+84.00						289.92	124418.42	540935.32	124708.34	540936.10	0°09'15"


BCS PHASE 2A INFRASTRUCTURE IMPROVEMENTS CITY PROJECT 2013—304 ALIGNMENT & CONTROL PLAN


BLOOMINGTON BLOOMINGTON MN 55431 BLOOMINGTON MN 55431 PHONE (952) 953-9700


REVISIONS
DESCRIPTION
ISSUED FOR BID 21433 6/10/14 LIC. # DATE


1 HEREBY CERTIFY THAT THIS PLAN WAS PREPARED BY ME ON UNDER MY DIRECT SUPERVISION AND THAT I AM A DULY OF SUPERVISION AND THAT I AM A DULY


SHEET: 31 OF 83

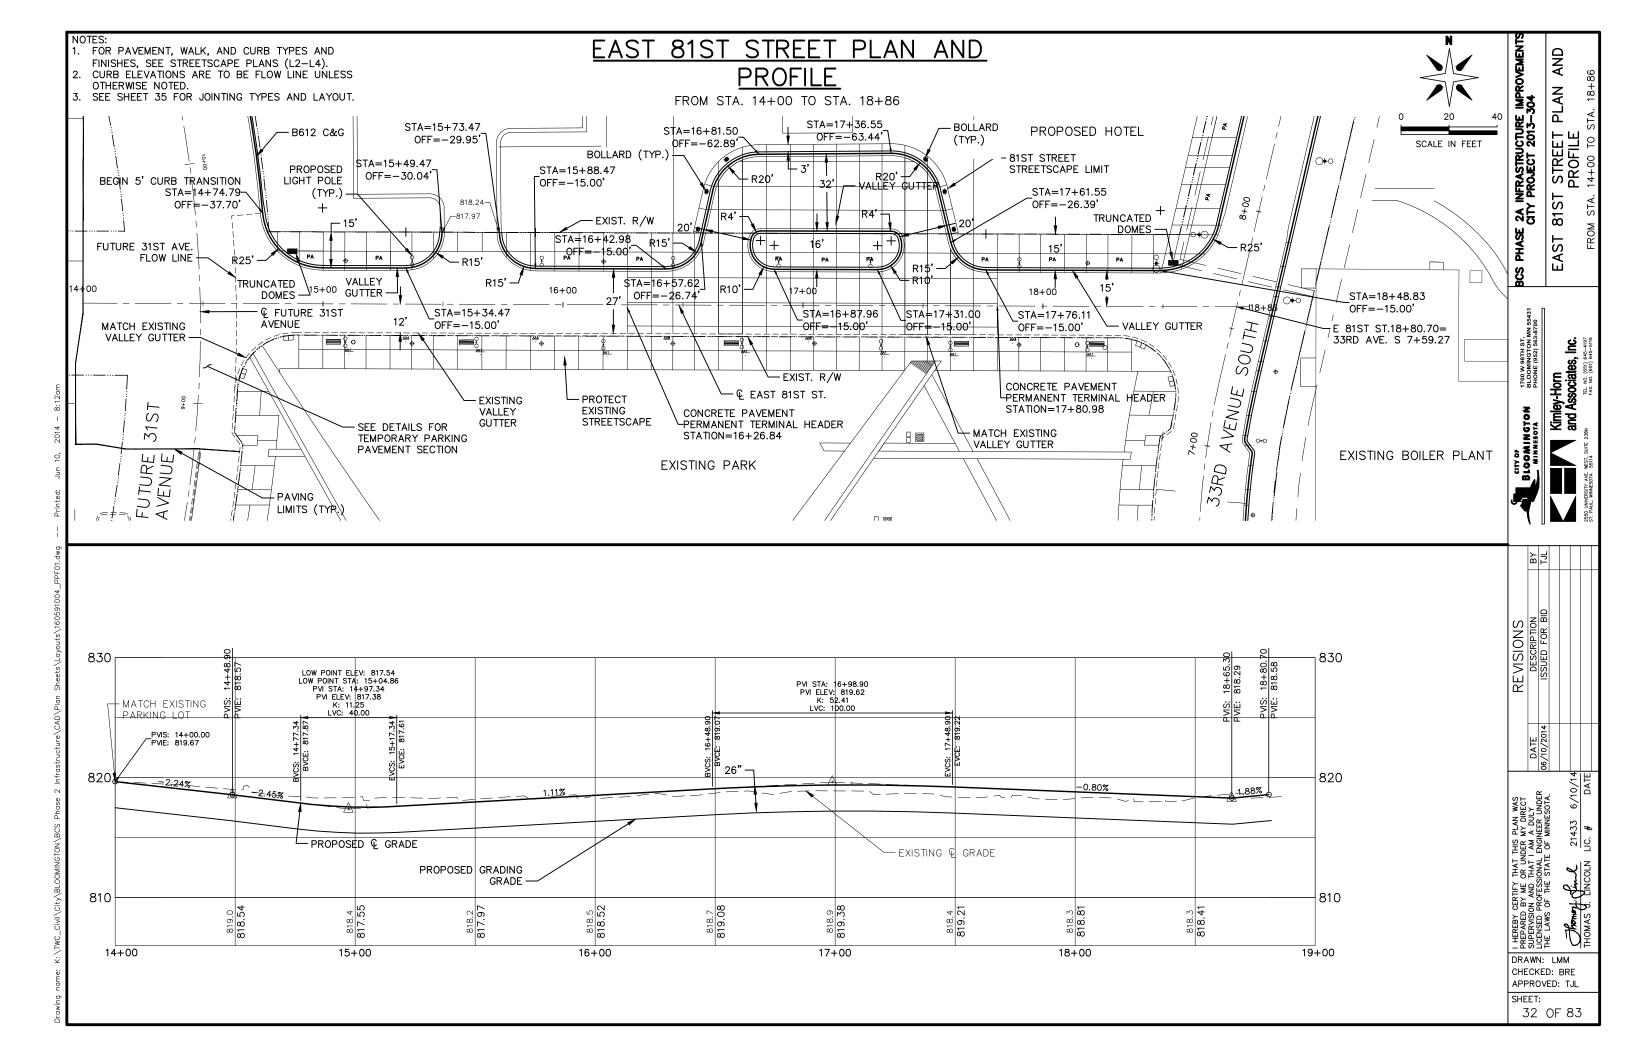

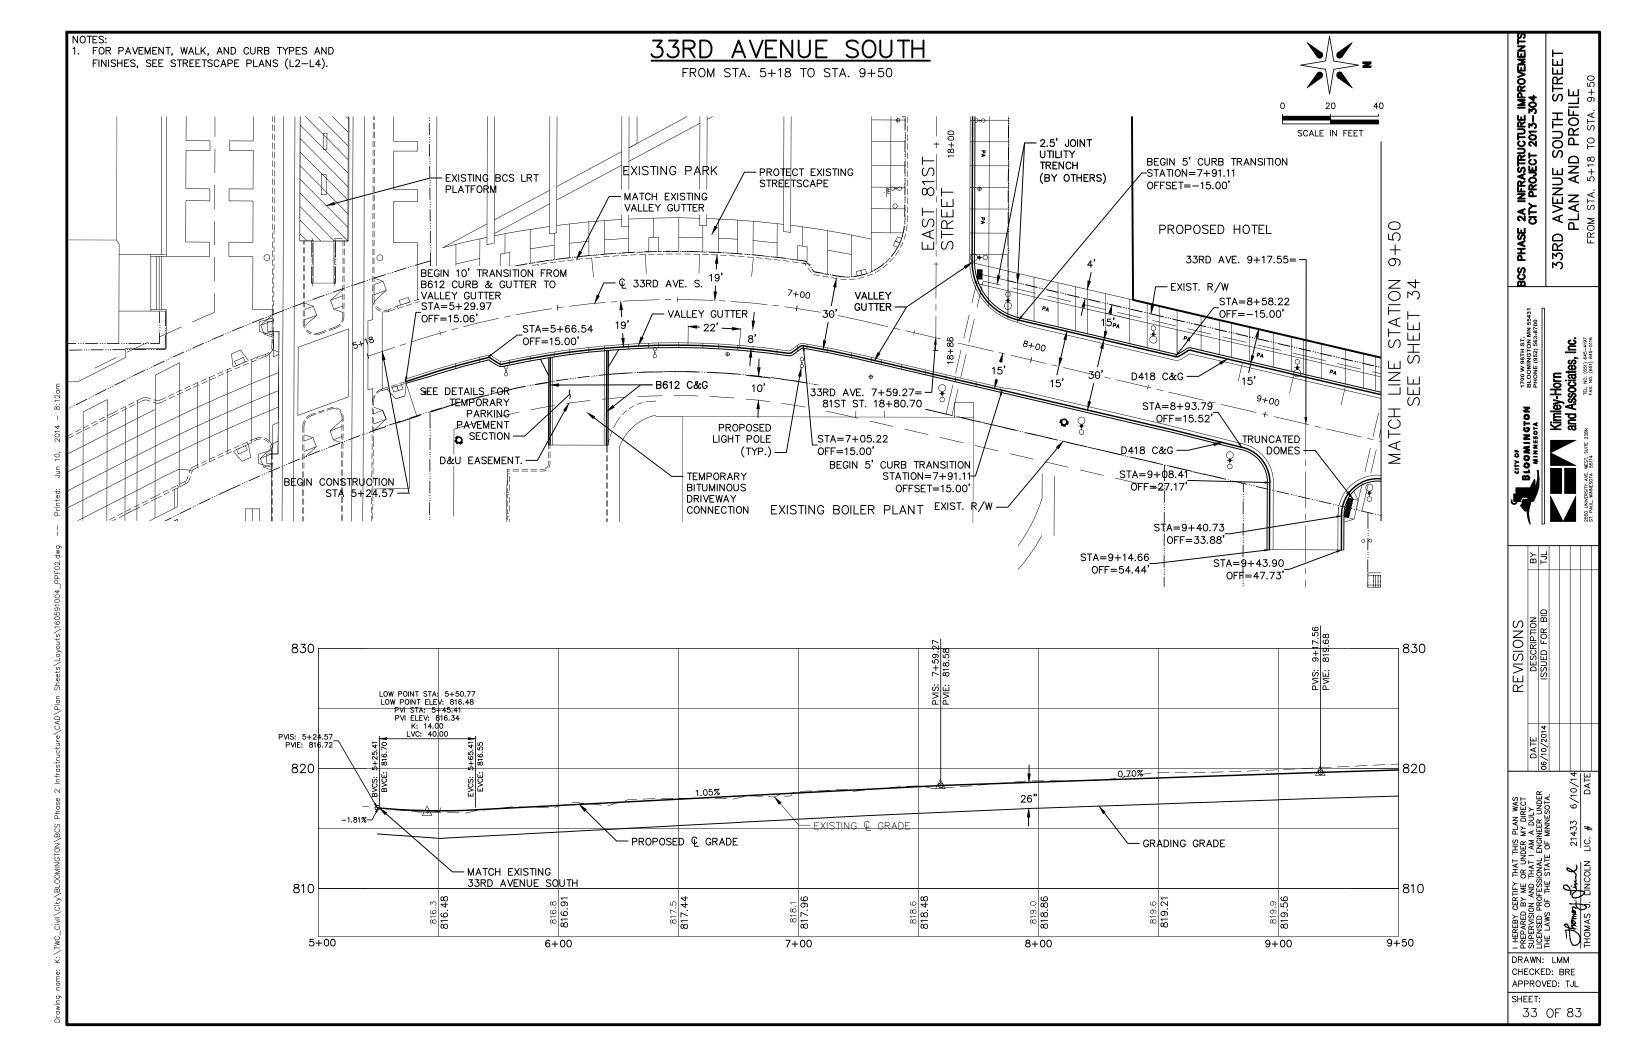

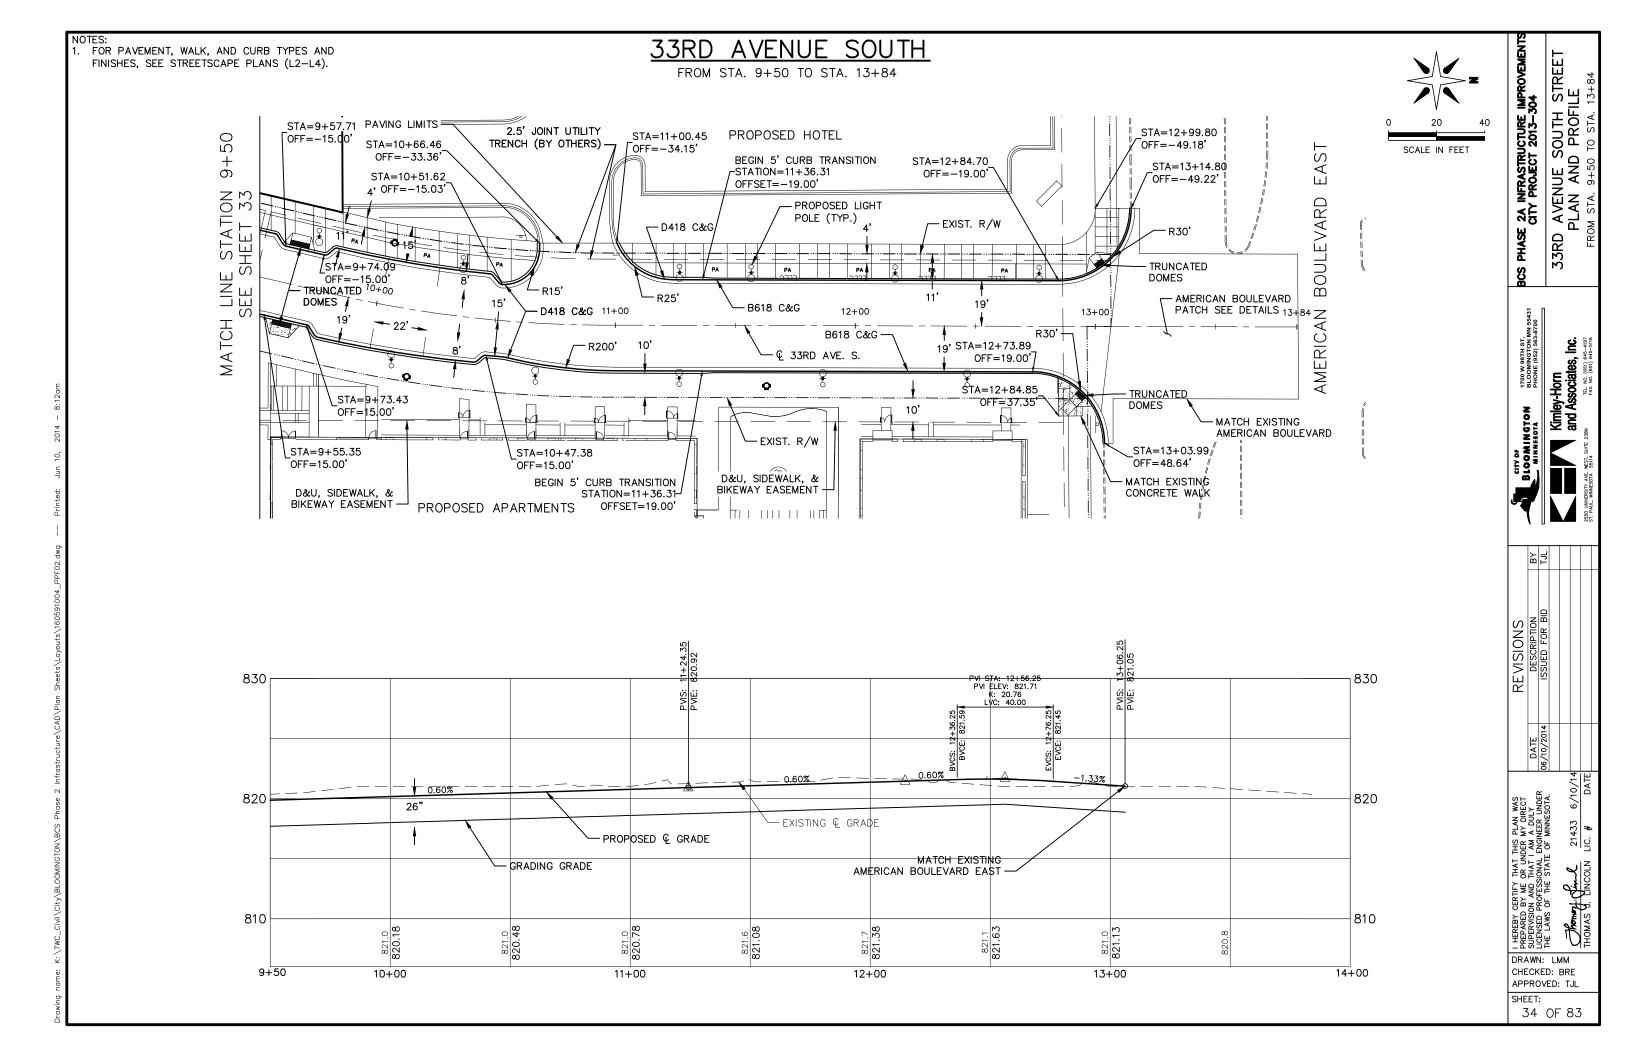

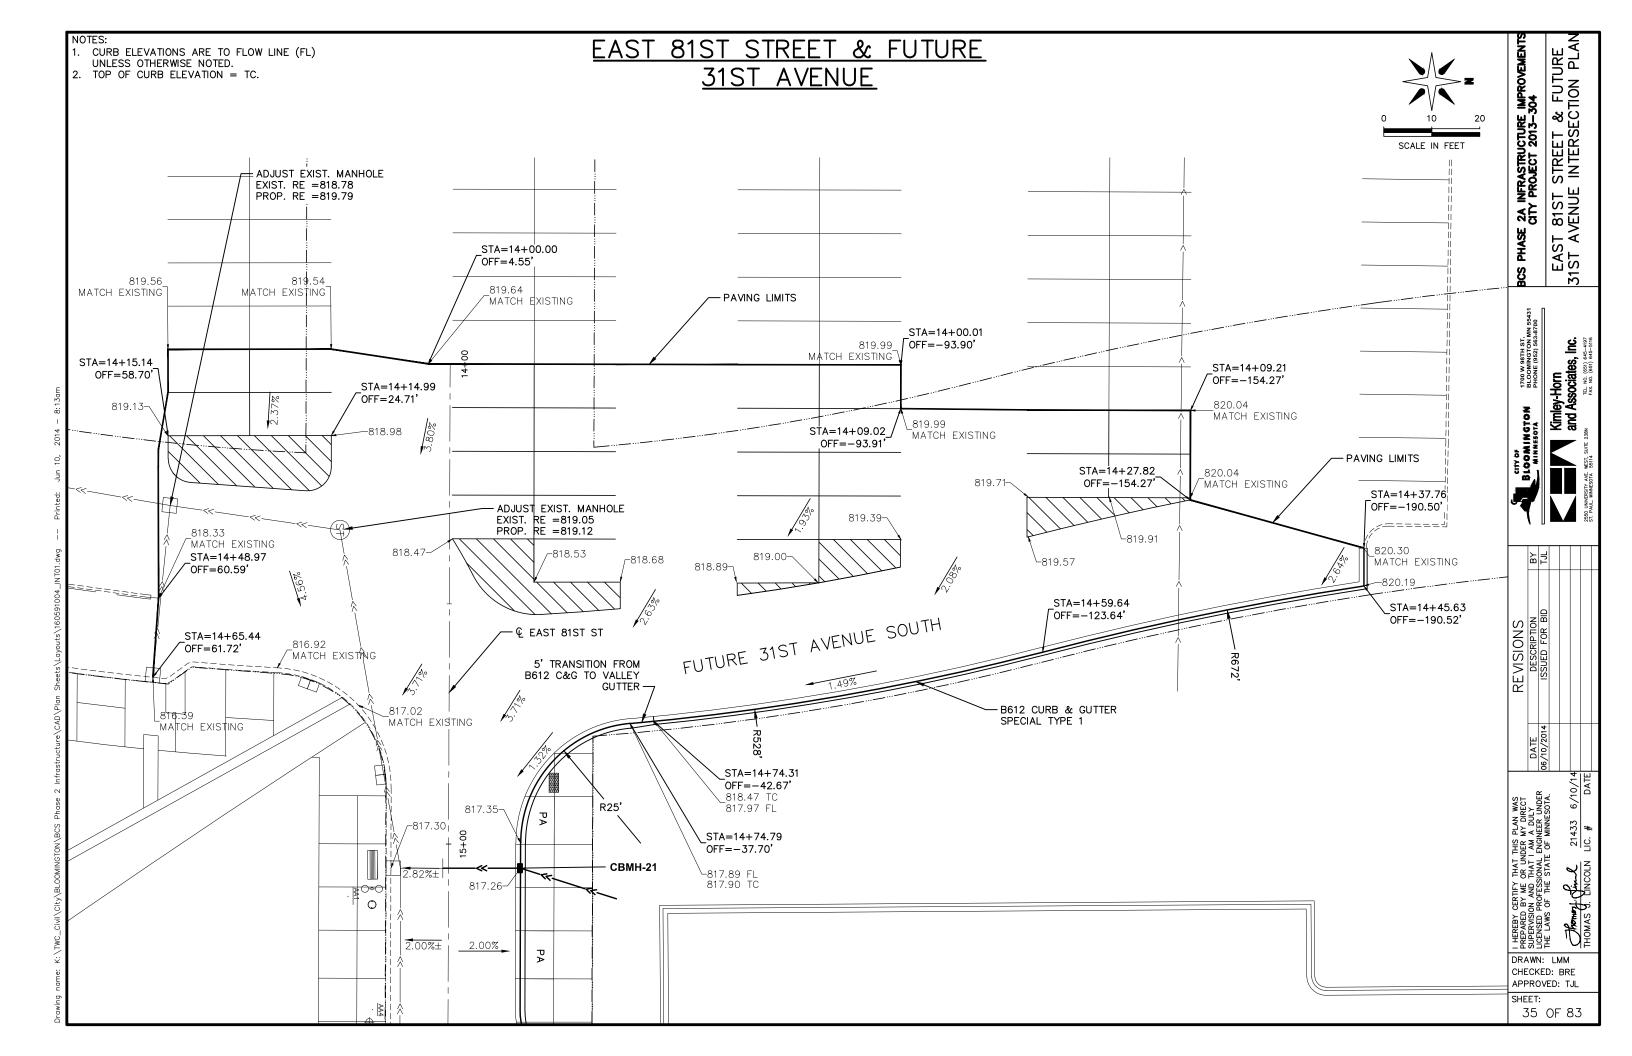

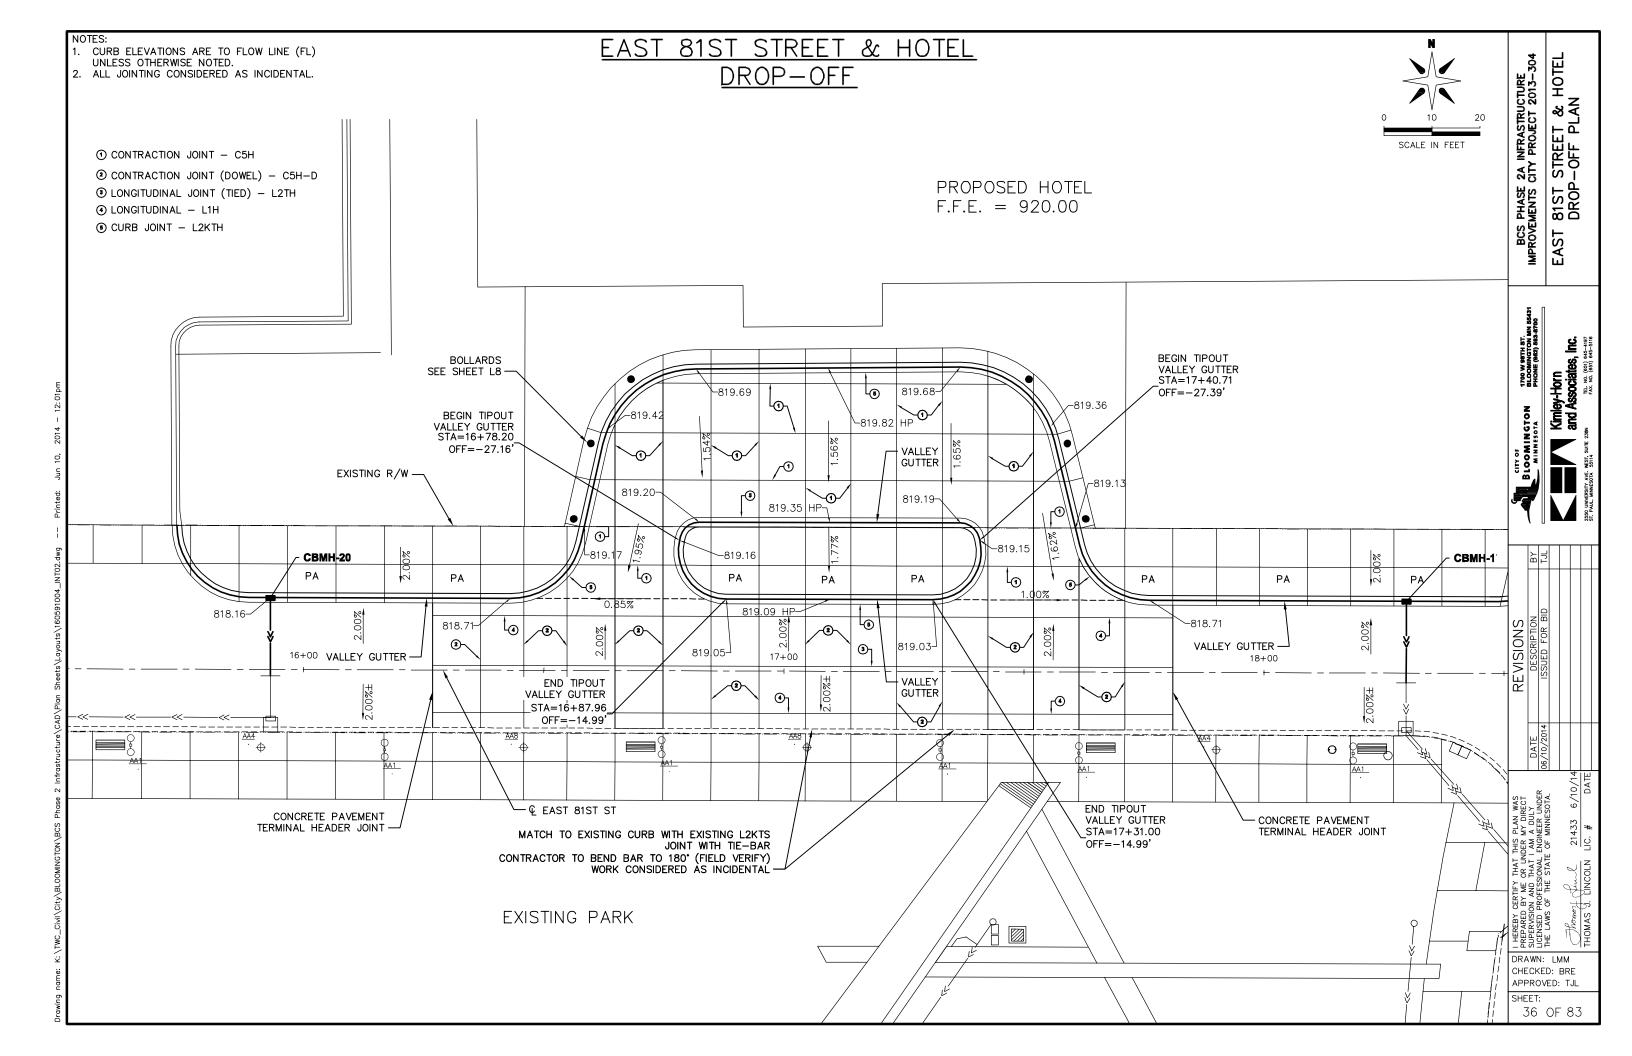

33RD AVENUE SOUTH INTERSECTIONS

DRAWN: LMM CHECKED: BRE APPROVED: TJL


NOTES:

CURB ELEVATIONS ARE TO FLOW LINE (FL)

UNLESS OTHERWISE NOTED. 2. TOP OF CURB ELEVATION = TC.

33RD AVENUE SOUTH & HOTEL ENTRANCE

33RD AVENUE SOUTH & AMERICAN BOULEVARD

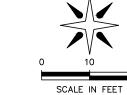


BCS PHASE 2A INFRASTRUCTURE IMPROVEMEN' CITY PROJECT 2013—304


33RD AVENUE SOUTH INTERSECTIONS


1700 W 98TH ST BLOOMINGTON MN 55431 PHONE (952) 563-8700


DRAWN: LMM CHECKED: BRE APPROVED: TJL


SHEET: 38 OF 83

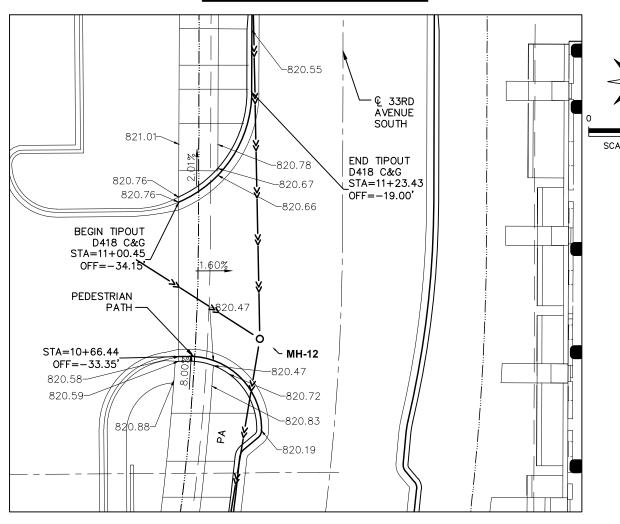


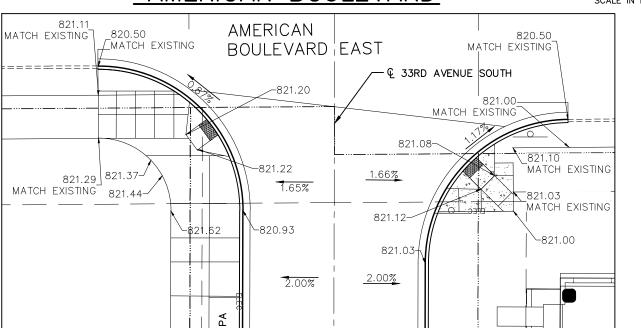


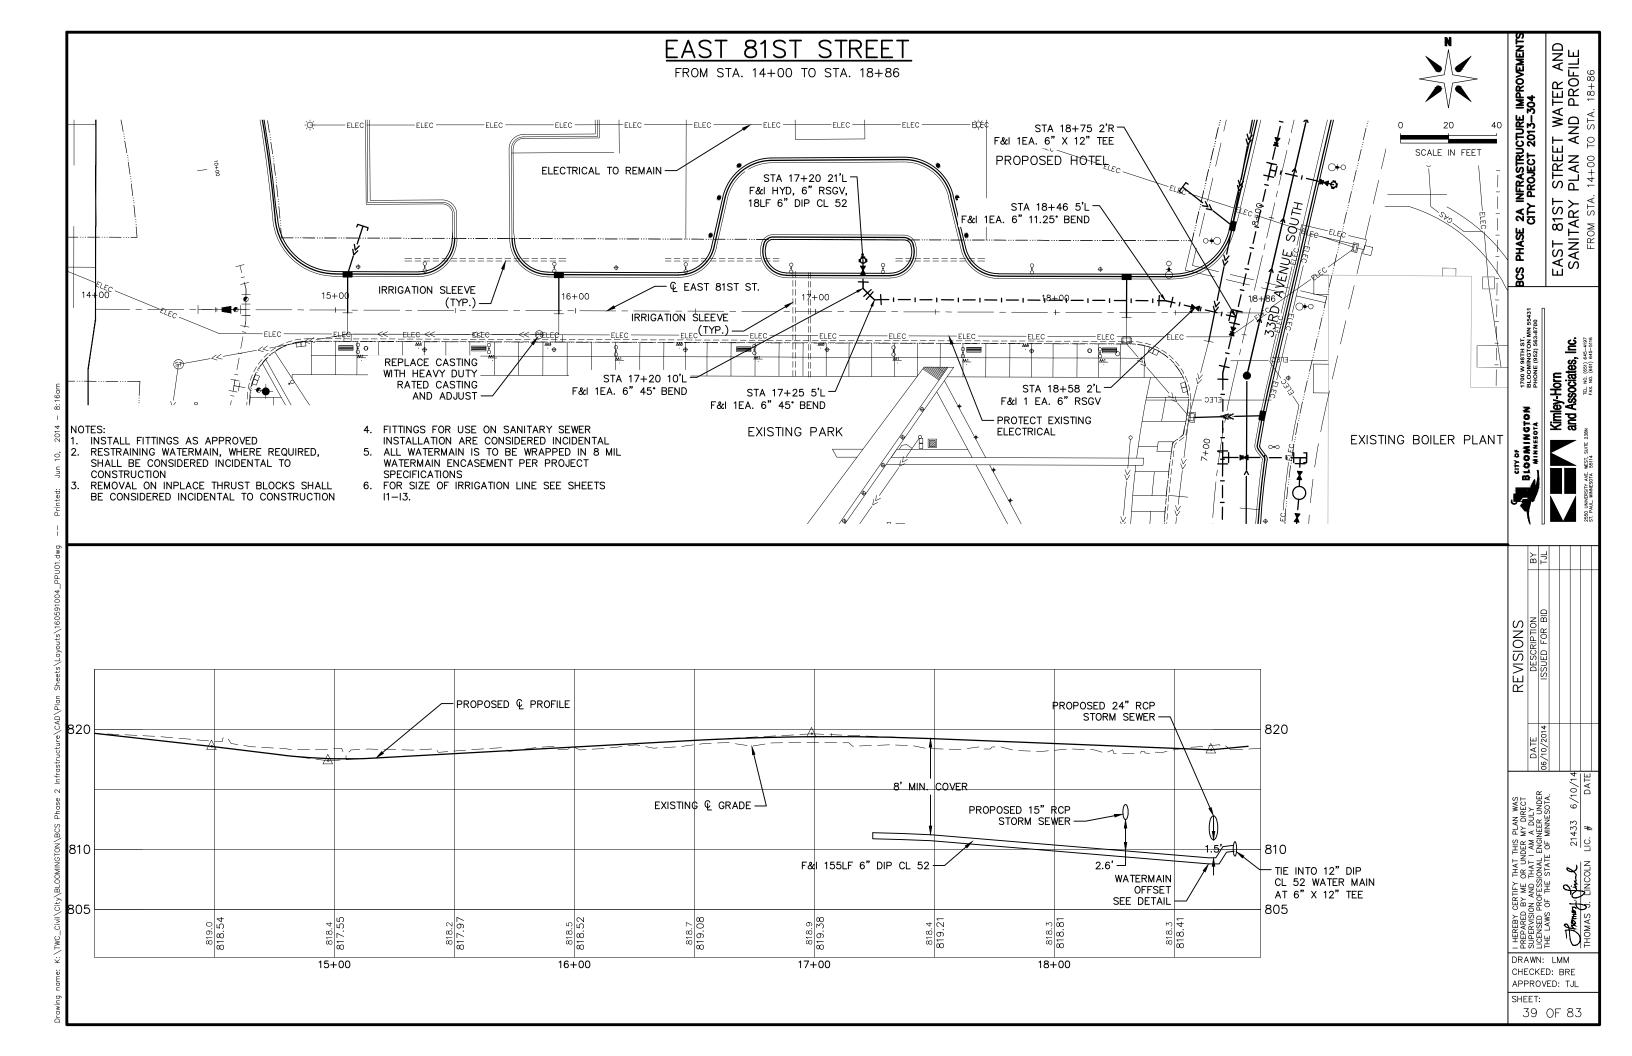

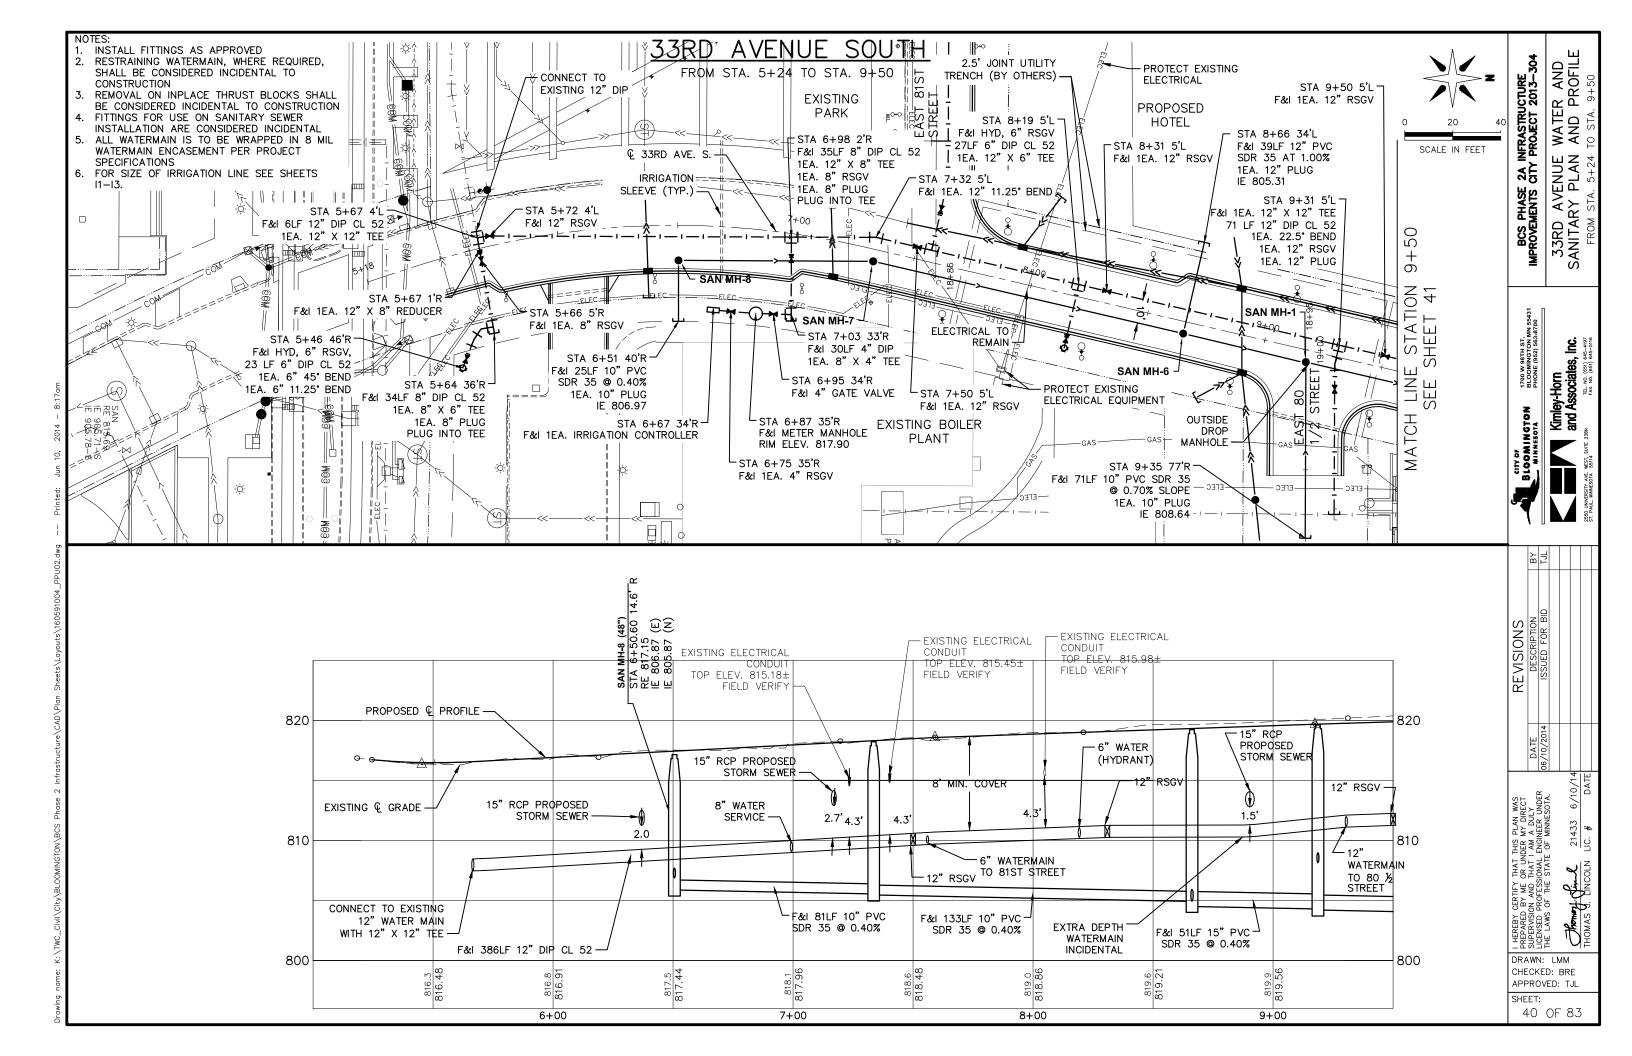


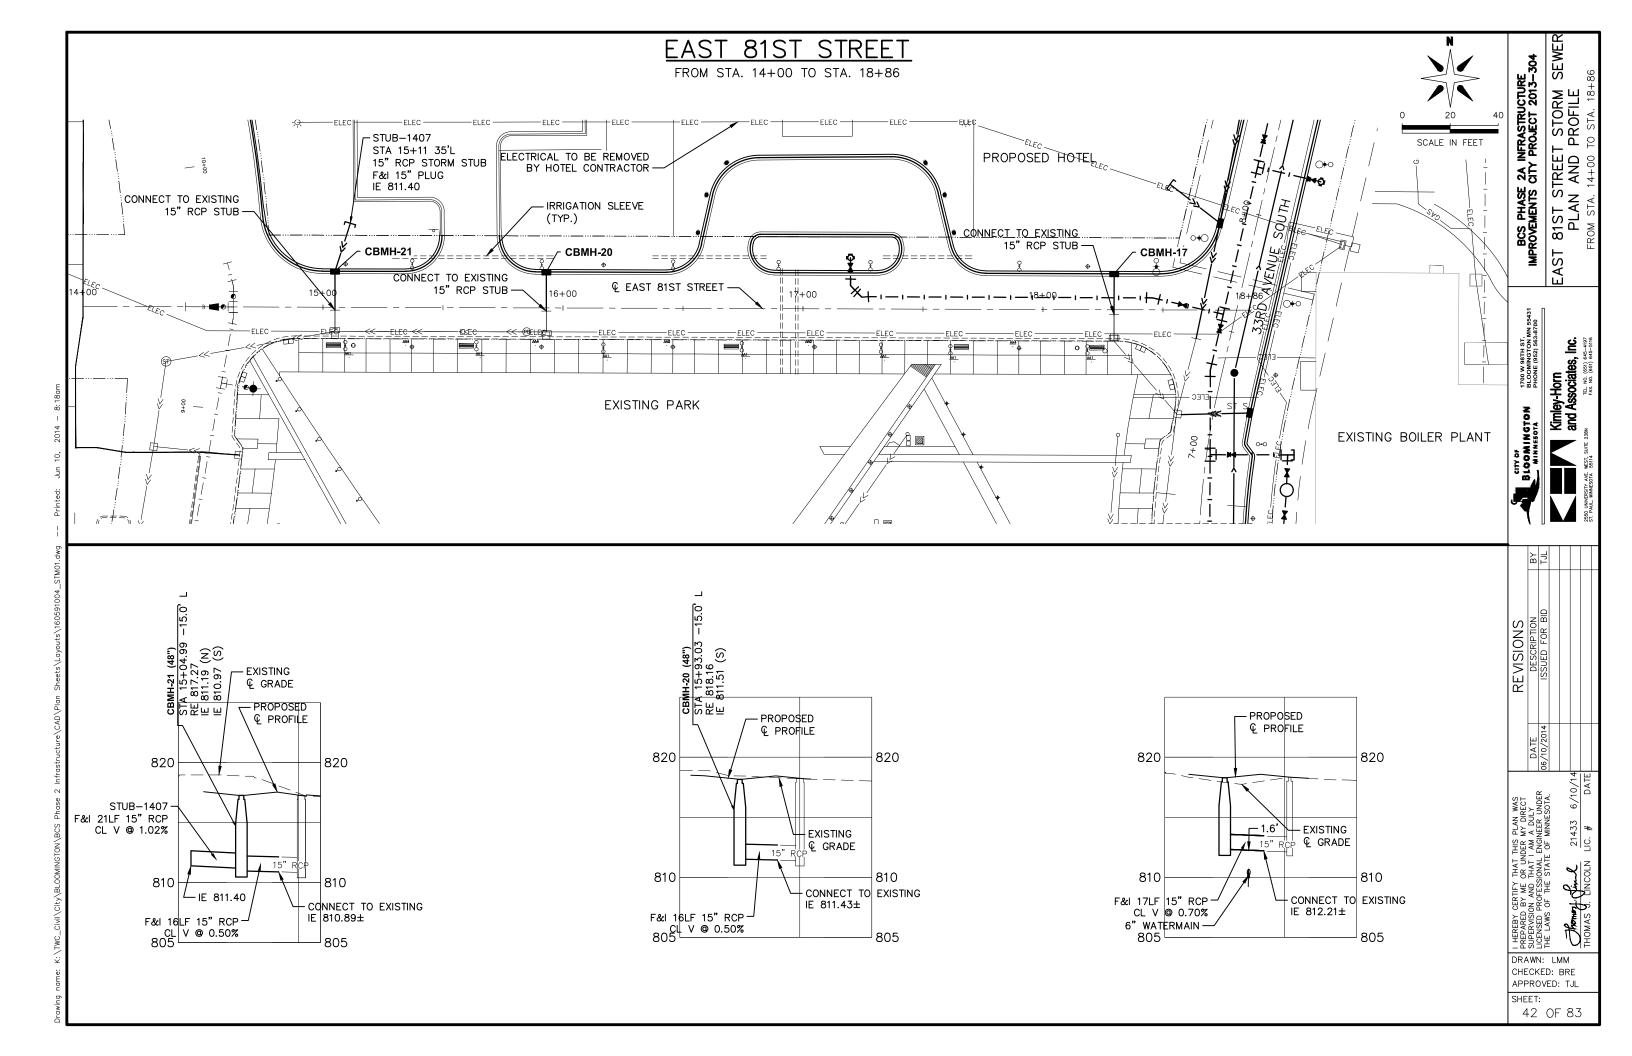


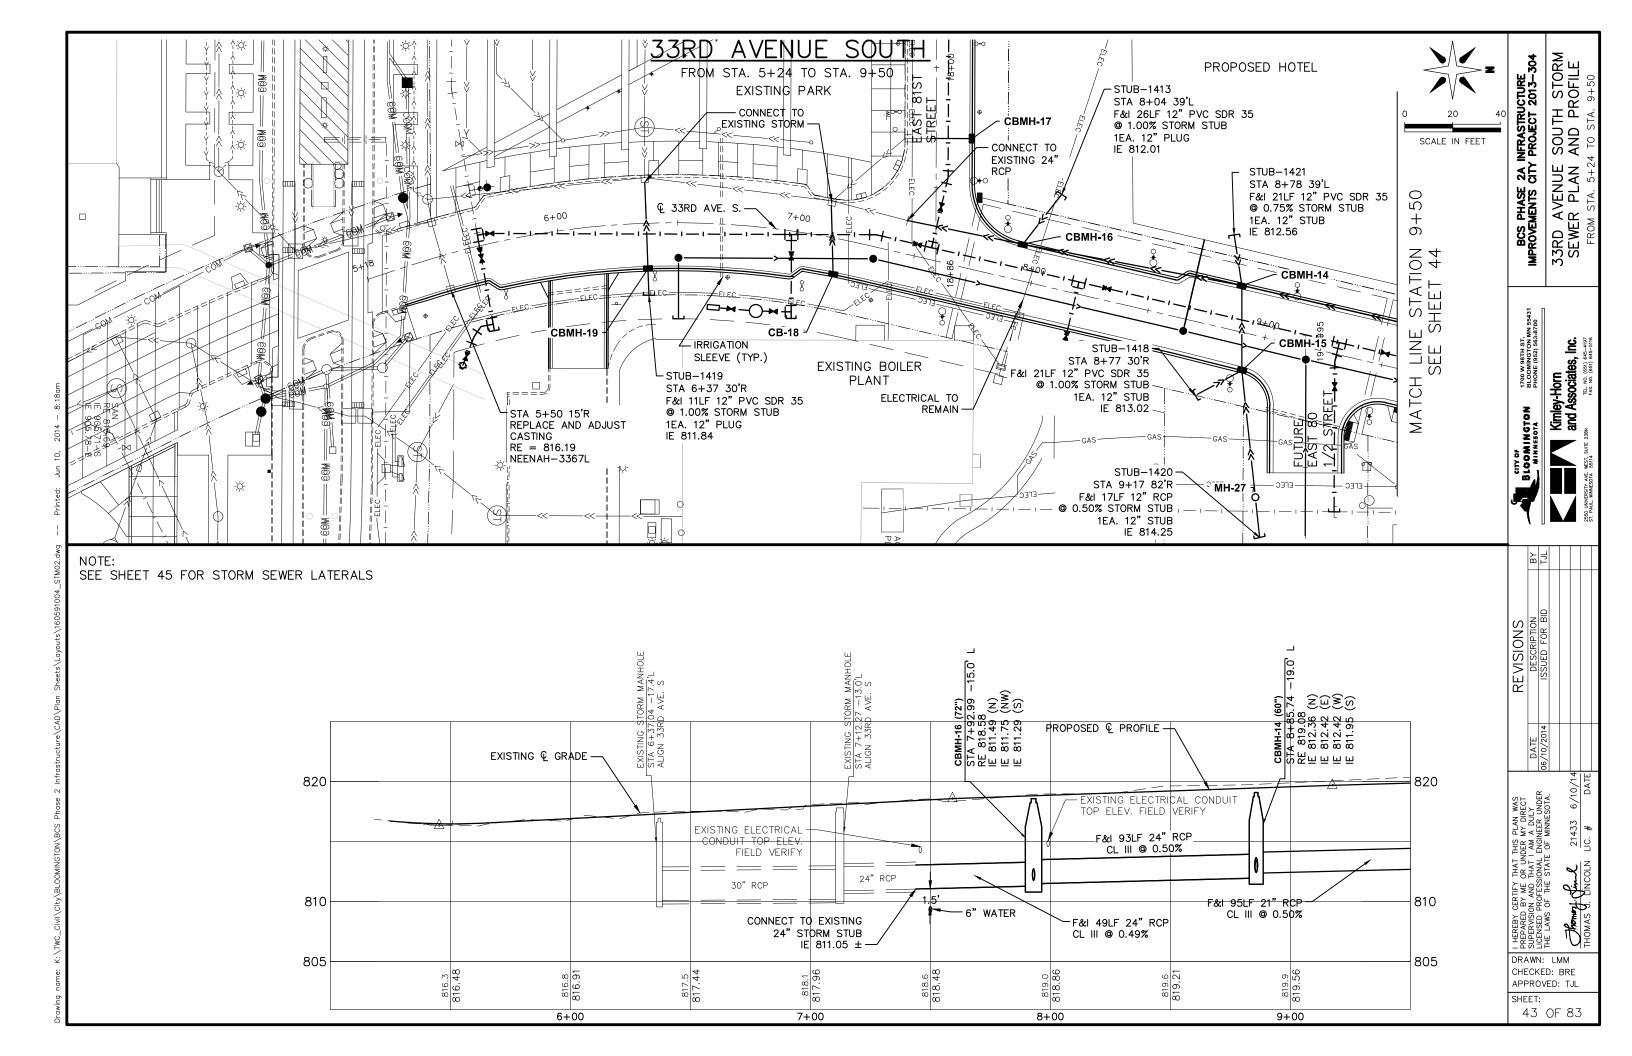


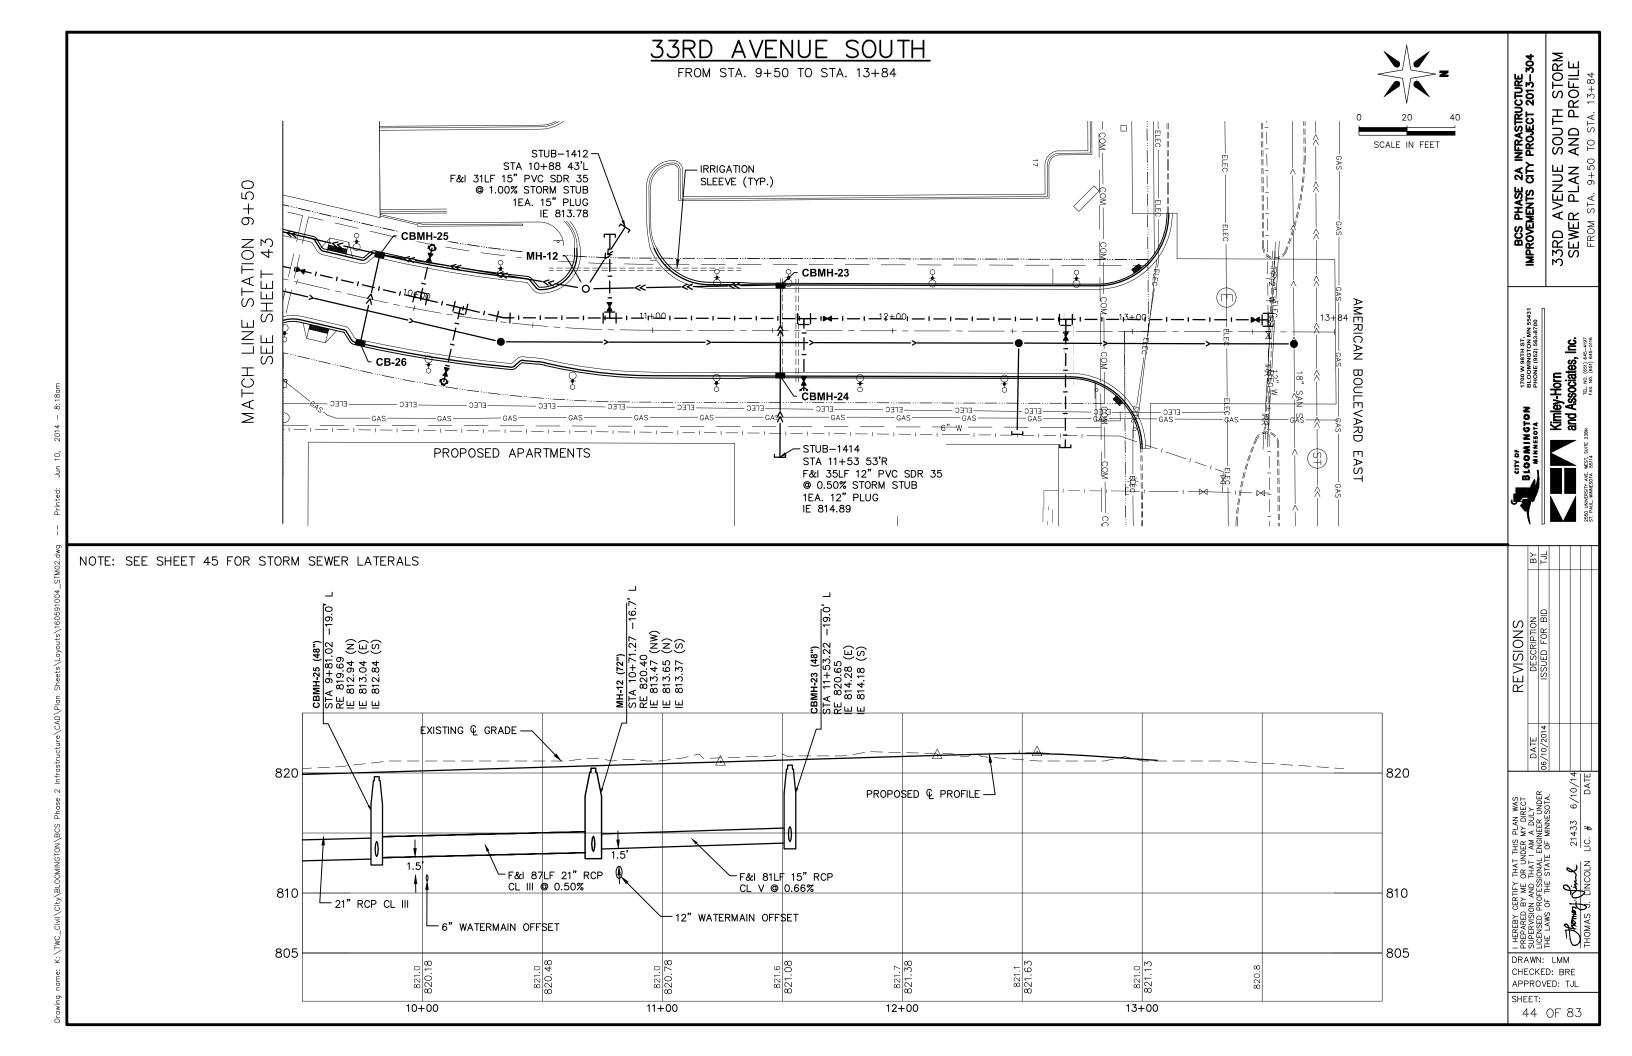



33RD AVENUE SOUTH

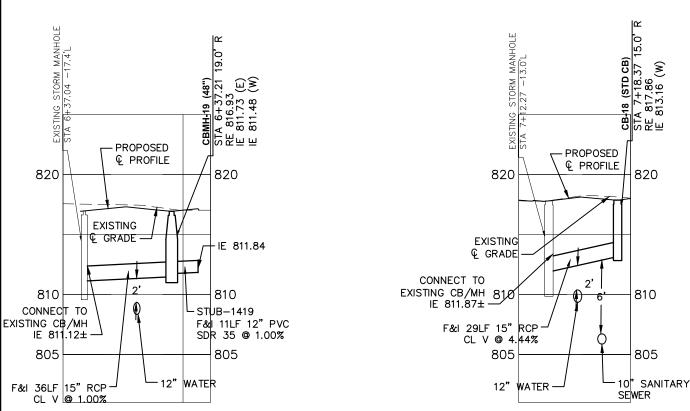

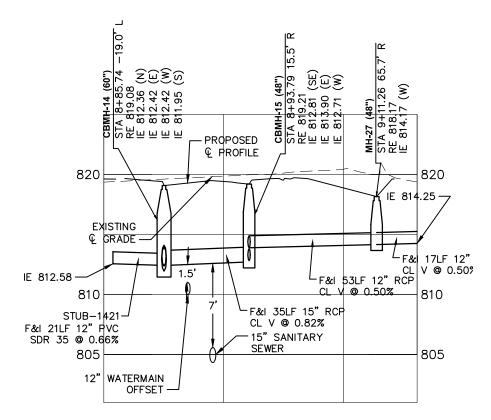

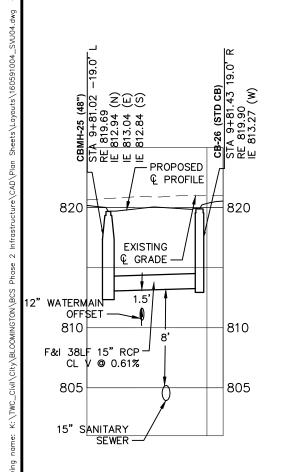

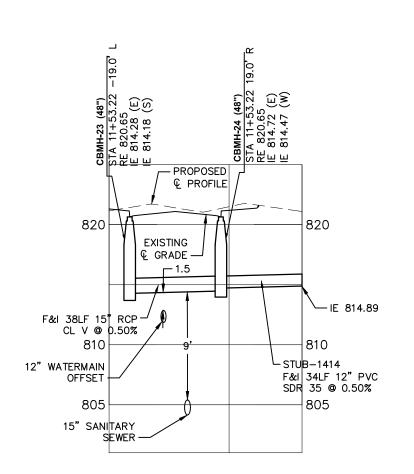

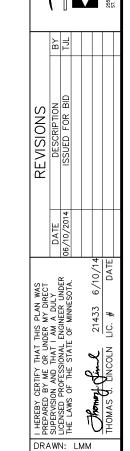

CHECKED: BRE

APPROVED: TJL SHEET:

45 OF 83

20

SCALE IN FEET

33RD AVENUE SOUTH LATERAL SECTION VIEWS FROM STA. 6+37 TO STA. 11+53

BCS PHASE 2A INFRASTRUCTURE IMPROVEMENTS CITY PROJECT 2013-304

1700 W 98TH ST BLOOMINGTON MN 55431 PHONE (952) 563-8700

BLOOMINGTON MINNESOTA

Kimley-Horn and Associates, Inc.

STRUCTURE -	FLOWL	INE LOCATION					STRUCTURE	2	,	LOW STRUCTURE	PAY HEIGHT	D	RAINS TO		10" PVC	12" PVC PIPE SEWER	15" PVC	12" RC PIPE SEWER DES	SEWER DES	SEWER DES	SEWER DES	PRECAST PLUG	CONNECT TO EXIST. STORM	CONNECT TO EXIST. DRAINAGE
NUMBER	ALICHMENT	STATION	OFF	SET	STRUCTURE	TOP OF	CA STING	STEPS	OUTLET	ELEV.		CTD NO	%	INLET				3006 CL V	3006 CL V	3006 CL III	3006 CL III		SEWER	STRUCTURE
	ALIGNMENT	STATION	LT.	RT.	DESIGN	CASTING ELEV.	ASSEMBLY TYPE	REQ'D	ELEV.	FEET	FEET	STR. NO.	GRADE	ELEV.	LINFT	LINFT	LINFT	LIN FT	LIN FT	LINFT	LIN FT	EACH	EACH	EACH
STUB-1419	33RD AVE S	6+37.22		30.00	N/A	N/A	N/A					CBMH-19	1.00	811.73		11						1		
CBMH-19	33RDAVE S	6+37.21		19.00	4020 - 48"	816.93	R-3362-L	N	811.48	811.48	5.45	EXISTING CB	1.00	811.12					36					1
CB-18	33RD AVE S	7+18.37		15.00	2' x 3'	817.86	R-3362-L	N	813.16	813.16	4.70	EXISTING CB	4.44	811.77					29					1
STUB-1413	33RD AVE S	8+03.90	38.60		NA	N/A	N/A					CBMH-16	1.00	811.75		26						1		
CBMH-16	33RD AVE S	7+92.99	15.00		4020 - 72"	818.58	R-3067-L	N	811.29	811.29	7.29	EXISTING CB	0.49	811.05							49		1	
CBMH-15	33RDAVE S	8+93.79		15.52	4020 - 48"	819.21	R-3067-L	N	812.71	812.71	6.50	CBMH-14	0.82	812.42					35					
STUB-1421	33RD AVE S	8+77.85	38.76		N/A	N/A	N/A					CBMH-14	0.66	812.42		21						1		
CBMH-14	33RD AVE S	8+85.74	19.00		4020 - 60"	819.08	R-3067-L	N	811.95	811.95	7.16	CBMH-16	0.50	811.49							93			
CB-26	33RDAVE S	9+81.43		18.97	2' x 3'	819.90	R-3067-L	N	813.27	813.27	6.63	CBMH-25	0.61	813.04					38					
CBMH-25	33RD AVE S	9+81.02	19.00		4020 - 48"	819.69	R-3067-L	N	812.84	812.84	6.85	CBMH-14	0.50	812.36						95				
STUB-1412	33RD AVE S	10+67.19	43.00		N/A	N/A	N/A					MH-12	1.00	813.47			31					1		
MH-12	33RD AVE S	10+71.27	16.66		4020 - 60"	820.40	R-2296	N	813.37	813.37	7.03	CBMH-25	0.50	812.94						87				
STUB-1414	33RDAVE S	11+53.22		40.00	N/A	NA	N/A					CBMH-24	0.51	814.72		34						1		
CBMH - 24	33RD AVE S	11+53.22		19.00	4020 - 48"	820.65	R-3067-L	N	814.47	814.47	6.18	CBMH-23	0.50	814.28					38					
CBMH-23	33RD AVE S	11+53.22	19.00		4020 - 48"	820.65	R-3067-L	N	814.18	814.18	6.47	MH-12	0.66	813.65					81					
STUB-1407	E81ST ST.	15+11.31	35.00		N/A	N/A	N/A					CBMH-21	1.02	811.19					21			1		
CBMH-21	E81ST ST.	15+04.99	15.00		4020 - 48"	817.27	R-3362-L	N	810.97	810.97	6.30	EXISTING CB	0.50	810.89					16				1	
CB-20	E81ST ST.	15+93.03	15.00		4020 - 48"	818.16	R-3362-L	N	811.51	811.51	6.64	EXISTING CB	0.50	811.43					16				1	
CB-17	E81ST ST.	18+29.63	15.00		4020 - 48"	818.29	R-3362-L	N	812.33	812.33	5.96	EXISTING CB	0.70	812.21					17				1	
STUB-1418	33RDAVE S	8+77		30.00	N/A	N/A	N/A					CHMH-15	1.00	812.81		21						1		
STUB-1420	33RD AVE S	9+17		82.00	N/A	N/A	N/A					MH-27	0.50	814.17				17				1		
MH-27	33RD AVE S	9+11.86		65.70	4020-48"	818.17	R-2561	N	814.17	814.17	4.00	CBMH-15	0.50	813.90				53						
									TOTALS						0	113	31	70	327	182	142	8	4	2

BCS PHASE 24 INFRASTRUCTURE IMPROVEMENTS CITY PROJECT 2013-304 DRAINAGE TABULATION

BLOOM IN GTON BTH ST.

BLOOM IN GTON BLOOM NO 5431
PHONE (952) 563-8700

21433 6/10/14 LIC. # DATE HEREBY CERTIFY THAT THIS PLAN WAS PREPARED BY WE OR UNDER MY DIRECT SUPERVISION AND THAT I AM BOLLY CALL OF THE STATE OF MINNESOTA.


HE LAWS OF THE STATE OF MINNESOTA.


HE LAWS OF THE STATE OF MINNESOTA.

HE MAN OF THE STATE OF MINNESOTA.

HE MAN OF THE STATE OF MINNESOTA.

SHEET:

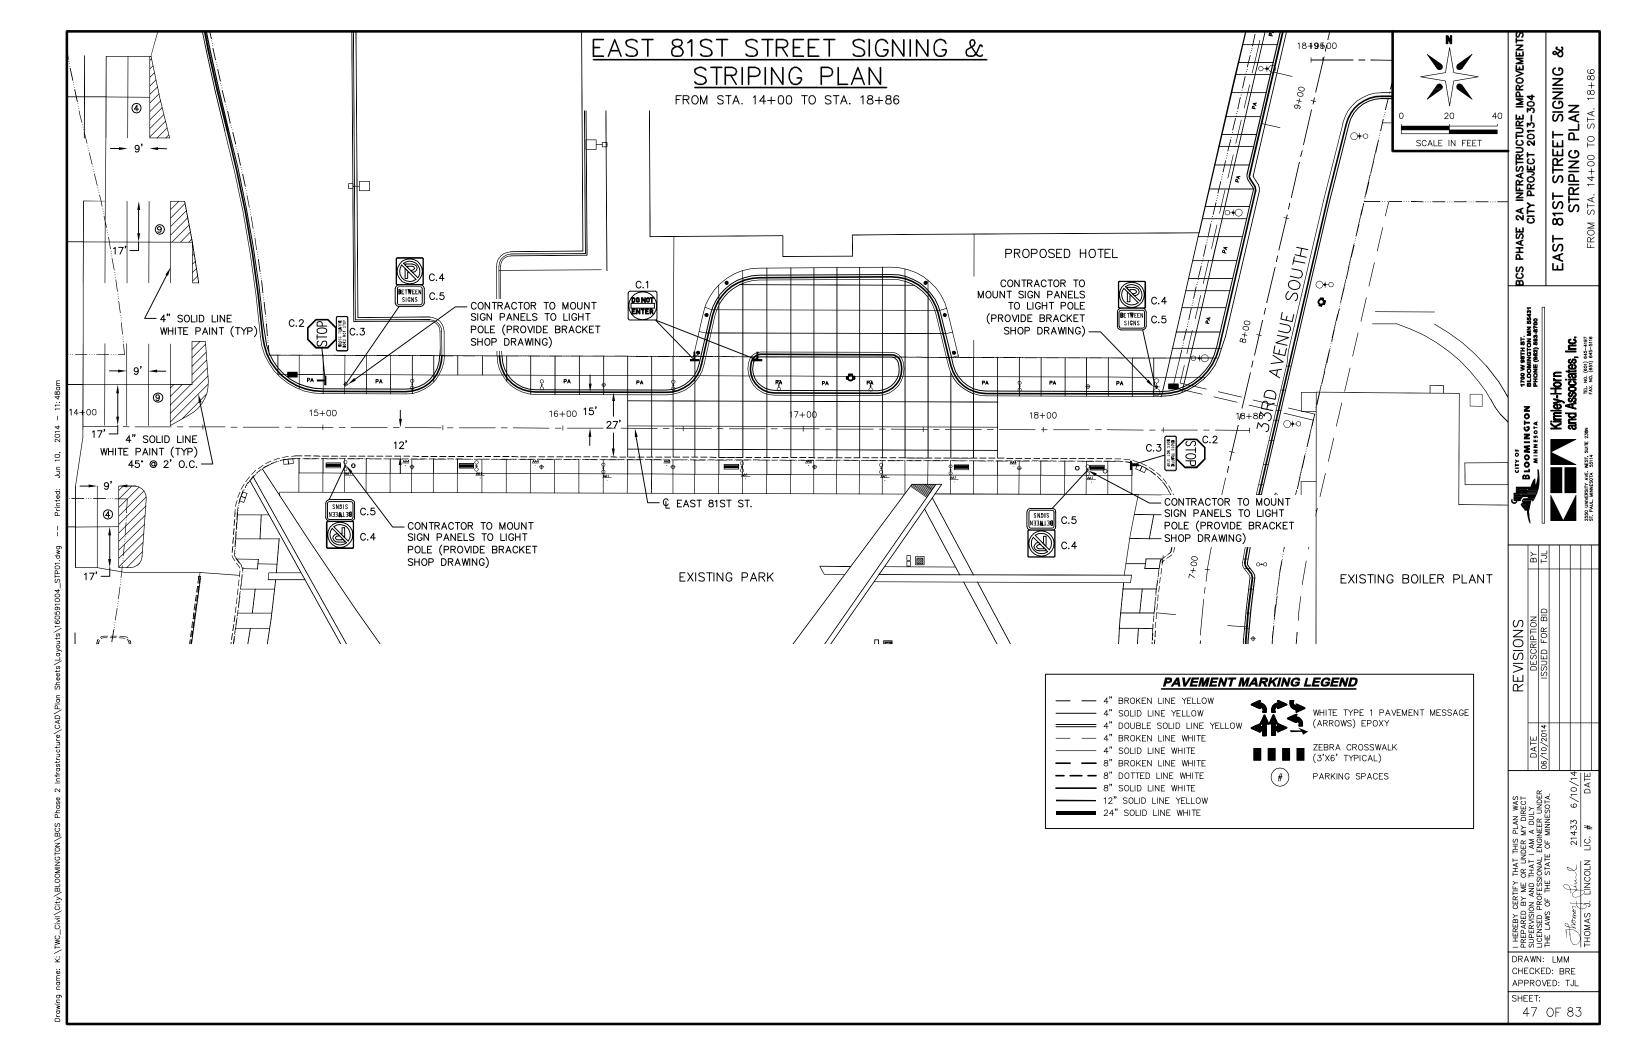

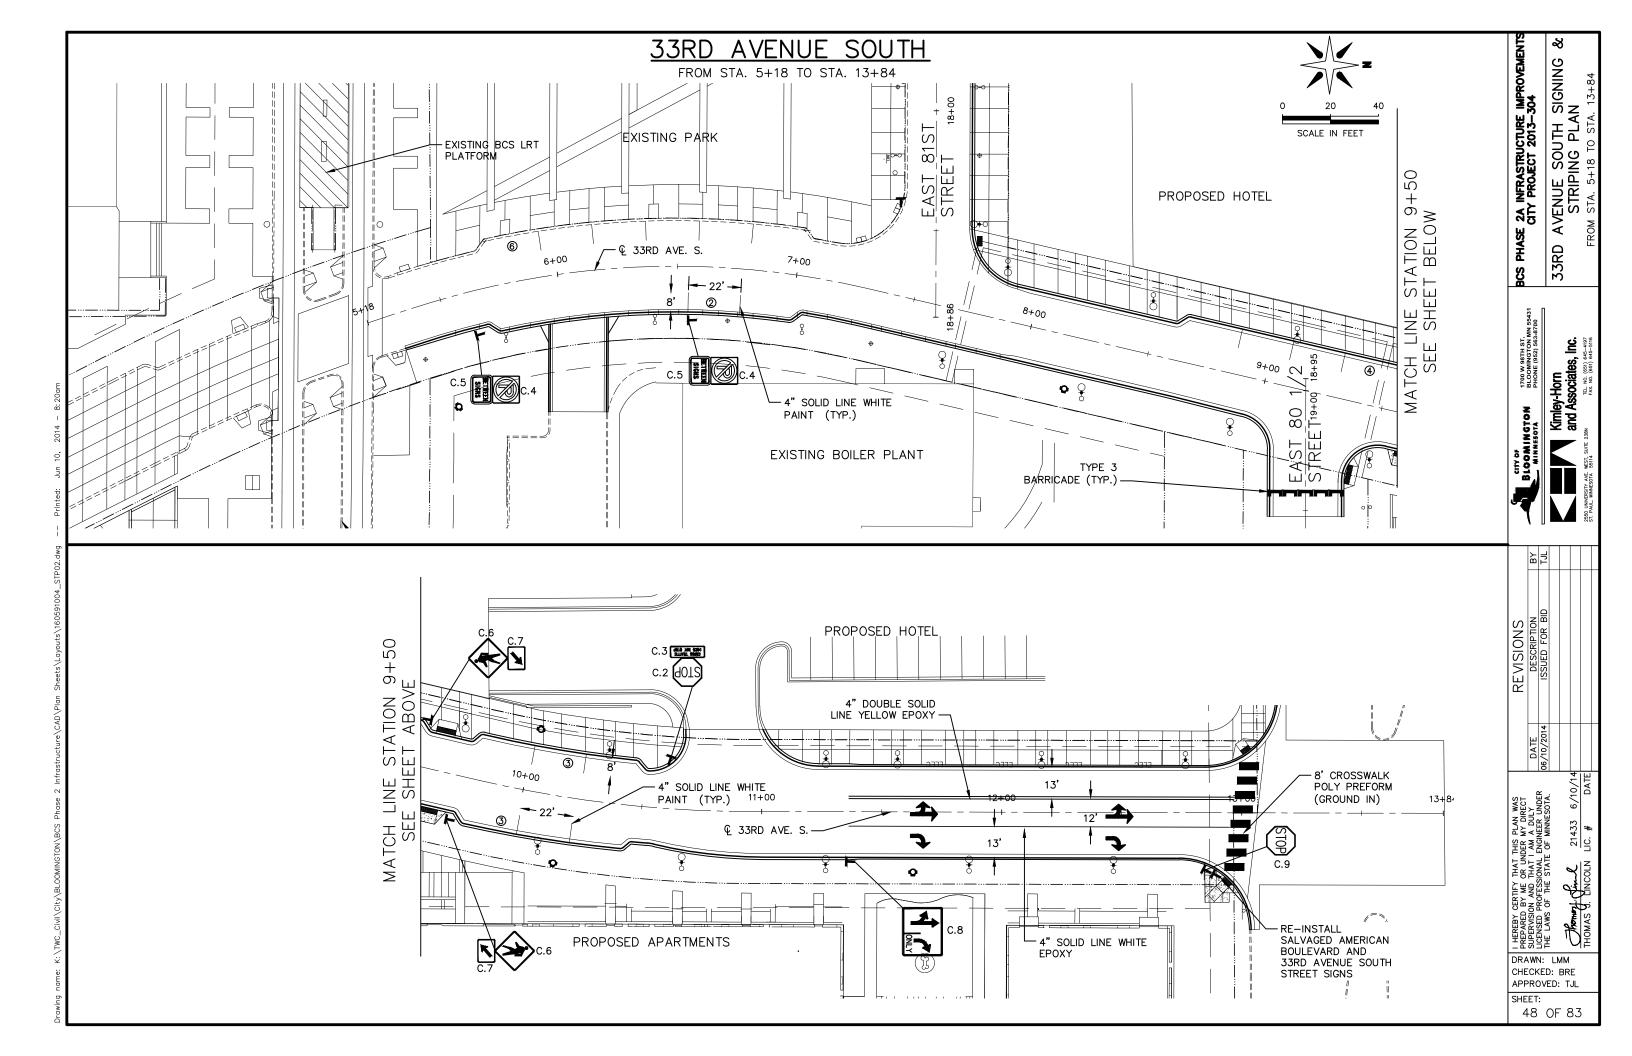

ALL TRAFFIC CONTROL DEVICES, INSTALLATION AND SIGNING SHALL CONFORM TO THE LATEST UNIFORM TRAFFIC CONTROL DEVICES (MMUTCD).

GROUND POST-MOUNTED SIGN TYPICAL INSTALLATION
Sign_Ground_Mount.dwa


SIGNING TABULATION & DETAILS

TOTALS

							SIGN PANELS	TYPE "C"		
			LENGTH	MOUNT	SIZE	AREA	TOTAL AREA			
ID	QUANTITY	NO. & TYPE	(FT)	HT. (FT.)	(IN.)	(SQ. FT.)	(SQ. FT.)	CODE	PANEL LEGEND	NOTES
C.1	2	1 U	12.5	7	30"X30"	6.25	12.50	R5-1	DO NOT ENTER	
C.2	3	1 U	13.5	8	30"X30"	6.25	18.75	R1-1	STOP	
C.3	3	-	ı	-	24"X12"	2.00	6.00	W4-4P	CROSS TRAFFIC DOES NOT STOP	MOUNT UNDER C.2
C.4	6	1U	12	7.5	18"X18"	2.25	13.50	R8-3	NO PARKING	
C.5	6	-	1	-	12"X9"	0.75	4.50	R8-3mP	BETWEEN SIGNS	MOUNT UNDER C.4
C.6	2	1U	13.5	8	30"X30"	6.25	12.50	W11-2	PEDESTRIAN	BLACK ON YELLOW
										BLACK ON YELLOW
C.7	2	-	ı	7	24"X12"	2.00	4.00	W16-7P(L)	DOWNWARD DIAGONAL ARROW	MOUNT UNDER C.6
									ADVANCED INTERSECTION LANE	
C.8	1	1U	12.5	7	36"X30"	7.50	7.50	R3-30DA	CONTROL	


79.25

	SALVAGED SIGN PANELS TYPE "C"											
			LENGTH	MOUNT	SIZE	AREA	TOTAL AREA					
ID	QUANTITY	NO. & TYPE	(FT)	HT. (FT.)	(IN.)	(SQ. FT.)	(SQ. FT.)	CODE	PANEL LEGEND	NOTES		
C.9	1	1 U	12.5	7	30"X30"	6.25	6.25	R1-1	STOP	REPLACE SIGN POST		

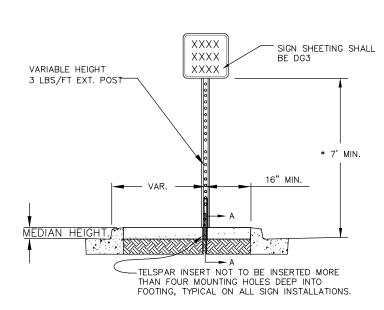

* 4' MIN. HEIGHT FOR SECONDARY SIGN

ISLAND MOUNT BREAK-AWAY SIGN TYPICAL INSTALLATION
Sign_Concrete_Mount.dwg 10/2012

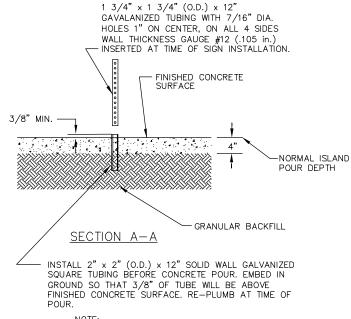

NOTE: ALL TRAFFIC CONTROL DEVICES, INSTALLATION AND SIGNING SHALL CONFORM TO THE LATEST VERSION OF THE MINNESOTA MANUAL ON UNIFORM TRAFFIC CONTROL DEVICES (MMUTCD).

TAIL 2A INFRASTRUCTURE CITY PROJECT 2013-304 શ્ર **TABULATION** BCS PHASE !

ω

SIGNING 1700 W 98TH ST. BLOOMINGTON MN 5543 PHONE (962) 563-8700


REVISIONS
DESCRIPTION
ISSUED FOR BID

21433 LIC. # I HEREBY C PREPARED SUPERVISIO LICENSED P THE LAWS

DRAWN: LMM CHECKED: BRE APPROVED: TJL

SHEET:

EAST 81ST STREET CROSS <u>SECTIONS</u>

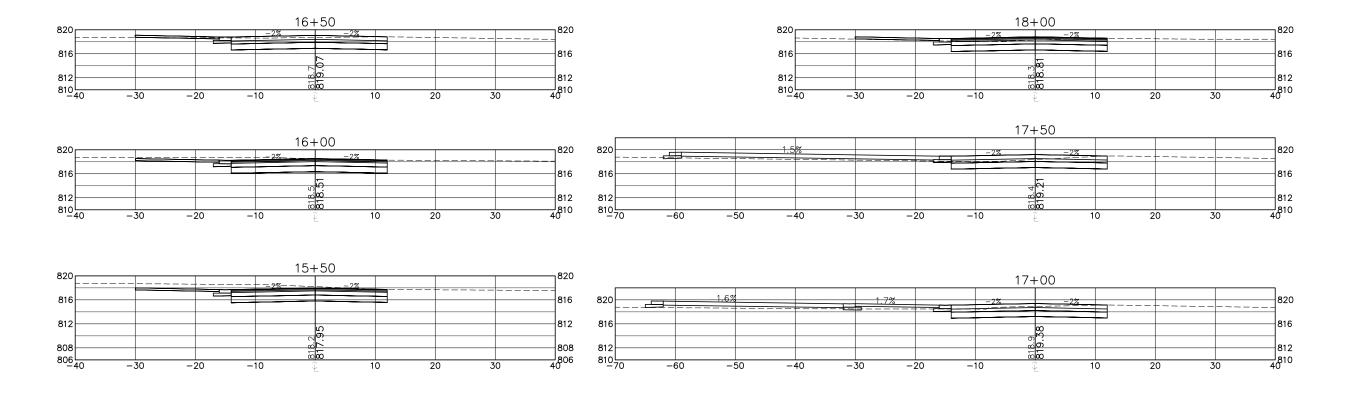

BCS PHASE 2A INFRASTRUCTURE IMPROVEMENTS CITY PROJECT 2013-304 EAST 81ST STREET CROSS SECTIONS

1700 W 98TH ST BLOOMINGTON MN 55431 PHONE (952) 563-8700

A SSOCIATES, INC. 2380 ASSOCIATES, INC. 51: PAUL, WINESSIY, SSIT, SUITE 2380 TAX. NO. (53): 655-1178 TAX. NO. (53): 655-1178 BLOOMINGTON MINNESOTA

B REVISIONS
DESCRIPTION
ISSUED FOR BID

21433 6/10/14 LIC. # DATE


I HEREBY CERTIFY THAT THIS PLAN WAS PREPARED BY ME OR UNDER MY DIRECT SUPERVISION AMO THAT I AM A DULY LICENSED PROFESSIONAL ENGINEER UNDER THE LAWS OF THE STATE OF MINNESOTA. THOMAS Y. LINCOLN


DRAWN: LMM CHECKED: BRE APPROVED: TJL


SHEET:


33RD AVENUE SOUTH CROSS <u>SECTIONS</u>


FROM STA. 5+50 TO STA. 9+25

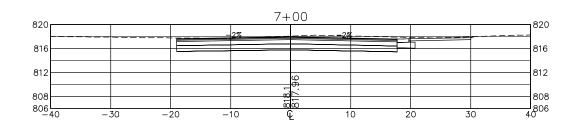


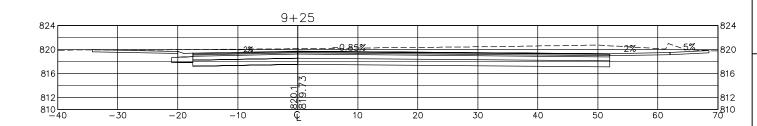


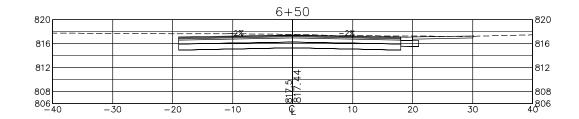


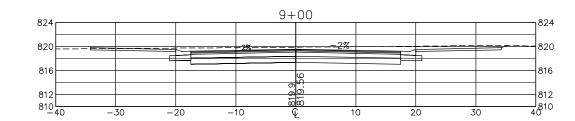

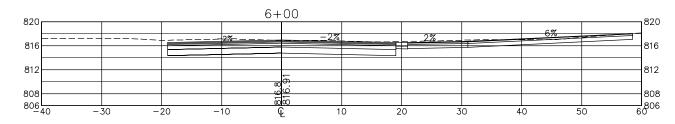

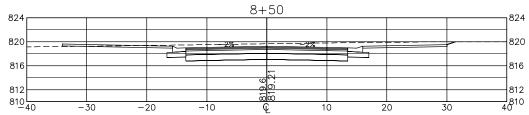

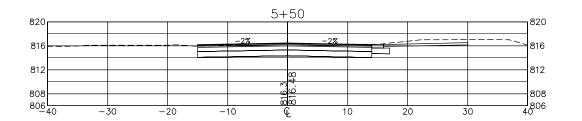

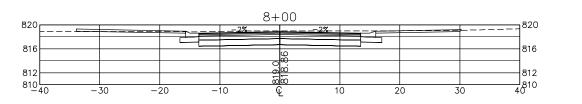

33RD AVENUE SOUTH CROSS SECTIONS FROM STA. 5+50 TO STA. 9+25 BCS PHASE 2A INFRASTRUCTURE IMPROVEMENTS CITY PROJECT 2013-304

1700 W 98TH ST. BLOOMINGTON MN 55431 PHONE (962) 563-8700

BLOOMINGTON MINNESOTA


REVISIONS
DESCRIPTION
ISSUED FOR BID

DRAWN: LMM CHECKED: BRE APPROVED: TJL

SHEET:

33RD AVENUE SOUTH CROSS <u>SECTIONS</u>

FROM STA. 9+50 TO STA. 12+50

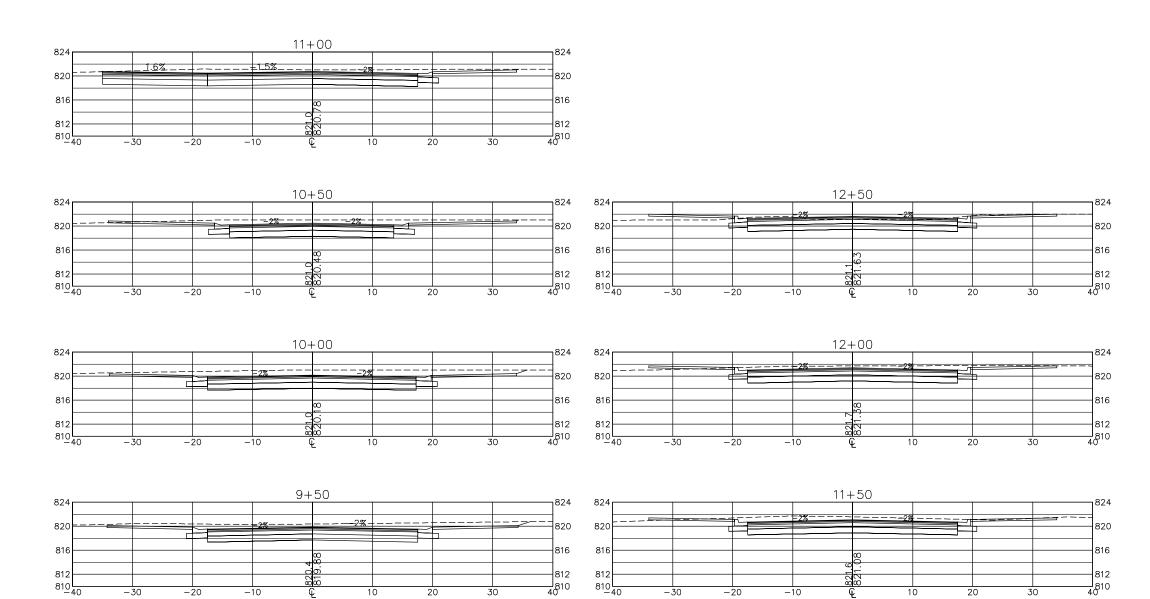

BCS PHASE 2A INFRASTRUCTURE IMPROVEMENTS CITY PROJECT 2013-304 33RD AVENUE SOUTH CROSS SECTIONS FROM STA. 9+50 TO STA. 12+50


1700 W 98TH ST. BLOOMINGTON MN 55431 PHONE (862) 563-8700


Kimley-Horn and Associates, Inc. TEL NO. (65) 645-457 FAX NO. (65) 645-457 BLOOMINGTON MINNESOTA

REVISIONS
DESCRIPTION
ISSUED FOR BID

DRAWN: LMM CHECKED: BRE APPROVED: TJL

SHEET: 52 OF 83

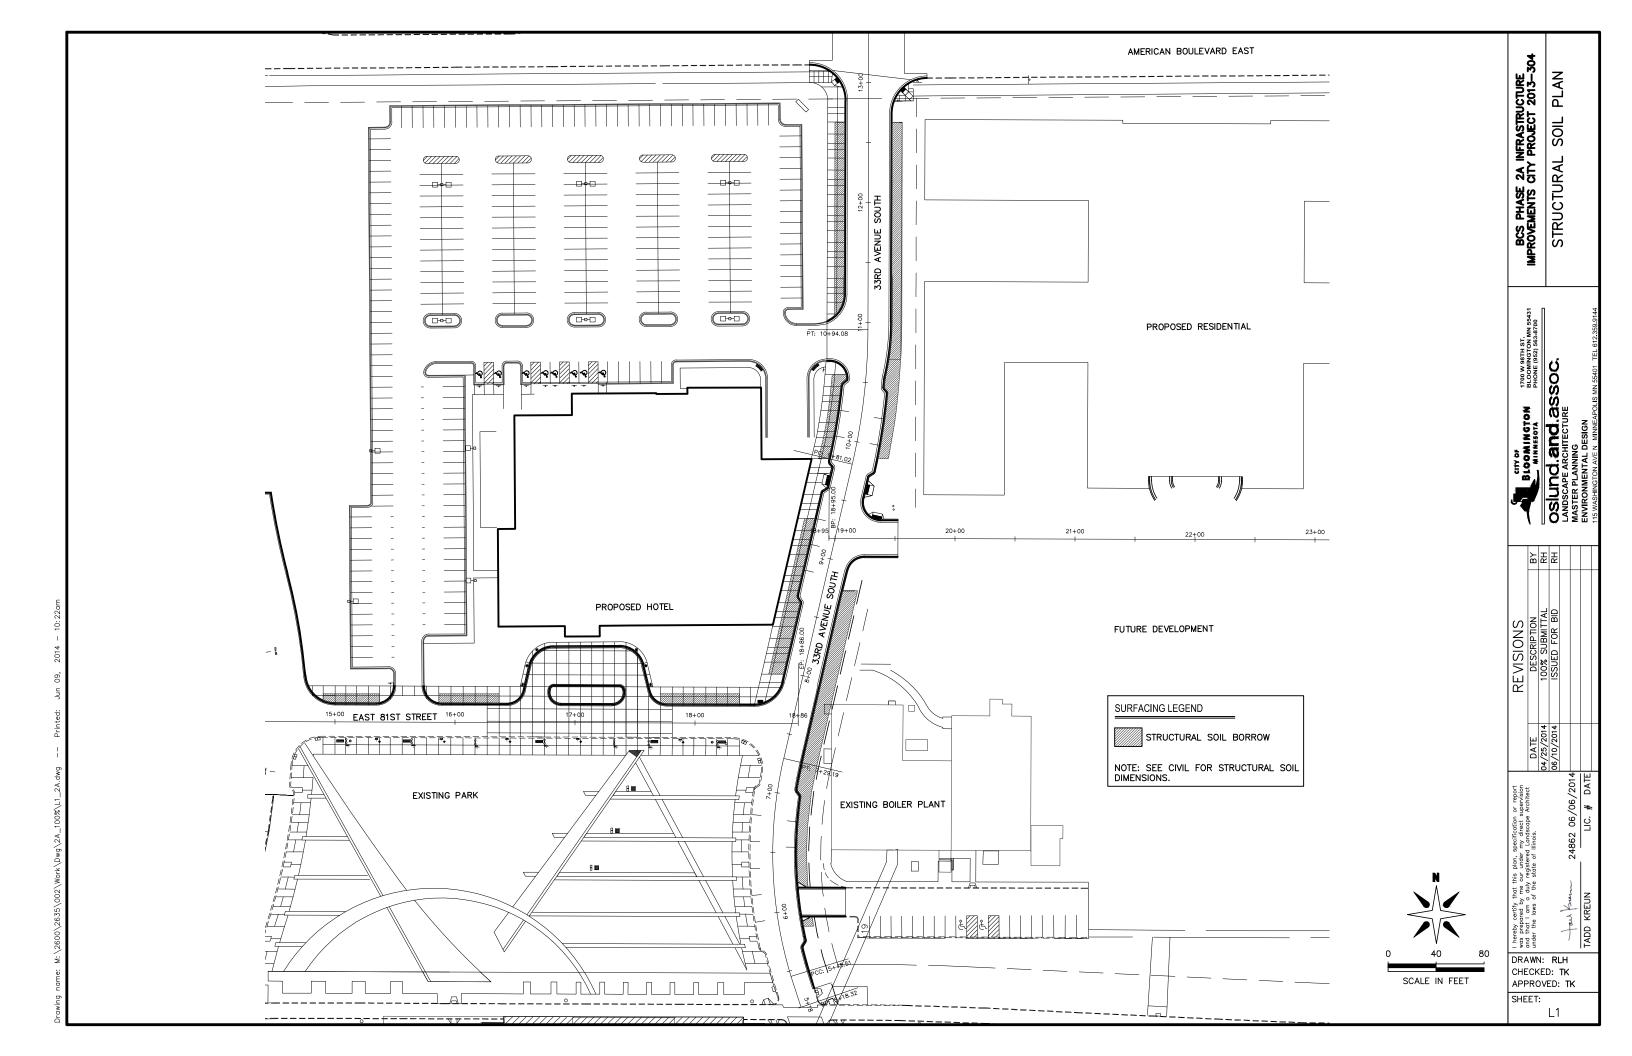

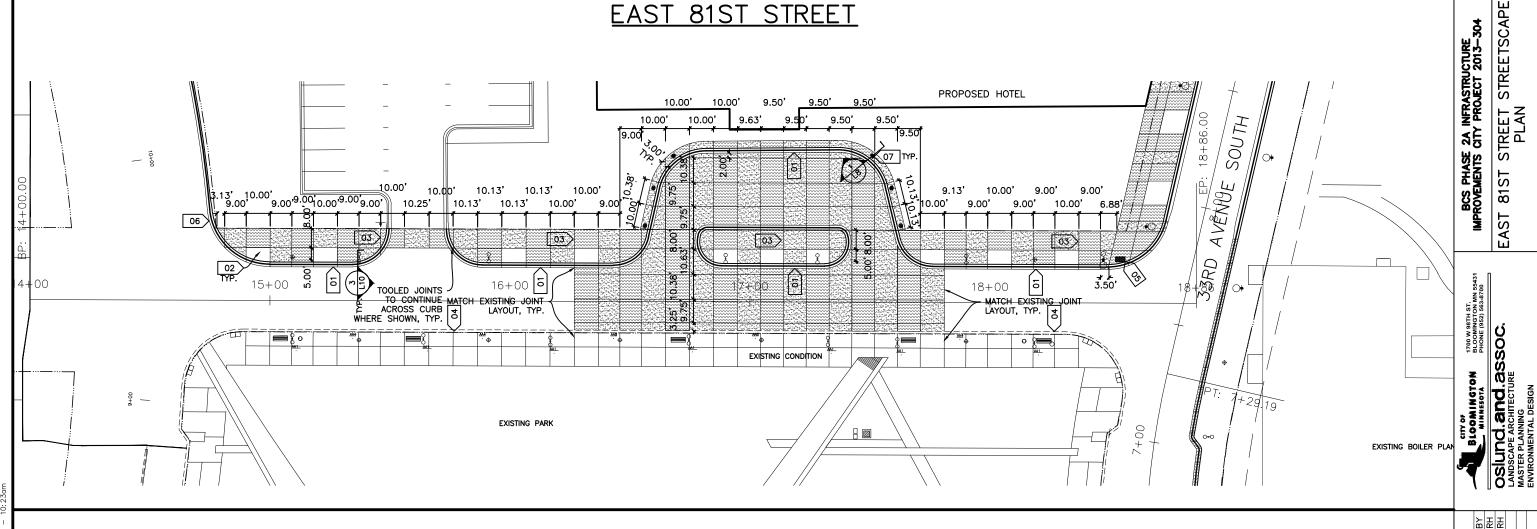

EAST 81ST STREET

LEGEND

- -BOLLARDS
- -STREET LIGHT (SEE ELECTRICAL)
- ⊕ −STREET LIGHT (SEE ELECTRICAL)
- ◆ −STREET LIGHT (SEE ELECTRICAL)

KEYNOTES

- 01 > 8" CONCRETE VALLEY GUTTER SPECIAL 4.
- 02 > PLANTING BED
- 03 CONCRETE SIDEWALK
- 04 EXISTING CURB
- 05 TRUNCATED DOMES SEE CIVIL
- CONCRETE CURB AND GUTTER DESIGN B612 SPECIAL 1
- 07 BOLLARD-SEE 1/L8


SURFACING LEGEND

5" CONCRETE WALK SPECIAL 3

5" CONCRETE WALK SPECIAL 4

NOTES

1. SEE CIVIL DRAWINGS FOR ROAD LAYOUT. LAYOUT.
2. SEE ELECTRICAL DRAWINGS FOR LIGHTING DETAILS.
3. PORTE—COCHERE MEDIAN TO HAVE 5" THICK CONCRETE. SEE CIVIL DRAWINGS.
4. USE DETAIL 2/L10 FOR ALL LIGHT BASE COVERS.
5. CONTINUE JOINTS THROUGH CURB FROM ADJACENT SIDEWALKS AS DIMENSIONED. AS DIMENSIONED. 5. 8" CONCRETE VALLEY GUTTER COLOR TO BE SPECIAL 4.

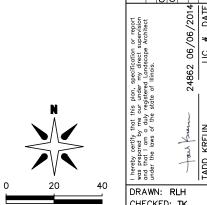


SCALE IN FEET

CHECKED: TK APPROVED: TK

SHEET: L2

REVISIONS
DESCRIPTION
100% SUBMITTAL
ISSUED FOR BID

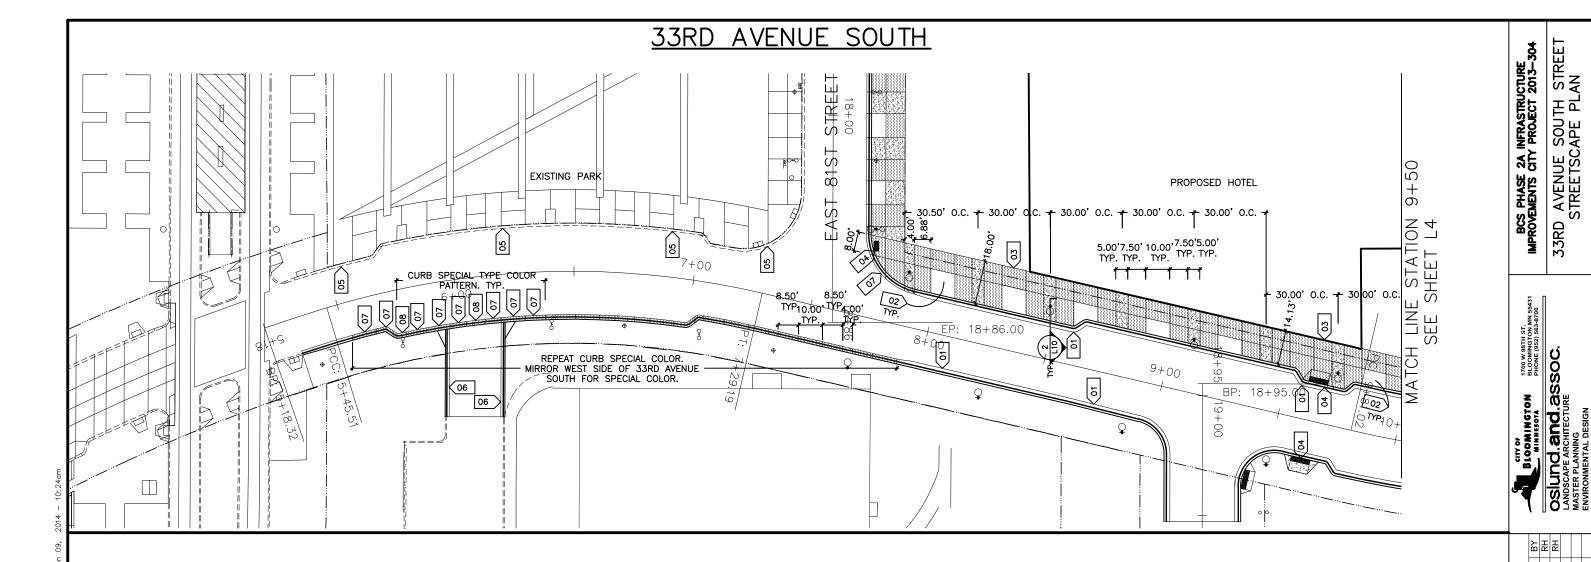

LEGEND

- ♦ -STREET LIGHT (SEE ELECTRICAL)
- STREET LIGHT (SEE ELECTRICAL)
- ⊕ −STREET LIGHT (SEE ELECTRICAL)

KEYNOTES

- O1 CONCRETE CURB AND GUTTER DESIGN D418 SPECIAL 1 - SEE CIVIL
- 02 PLANTING BED
- 03 CONCRETE SIDEWALK
- 04 TRUNCATED DOMES SEE CIVIL
- 05 EXISTING CURB
- 06 CONCRETE CURB AND GUTTER DESIGN B612 SPECIAL 1 SEE CIVIL
- 07 8" CONCRETE VALLEY GUTTER SPECIAL TYPE 4.
- 08 8" CONCRETE VALLEY GUTTER SPECIAL TYPE 3.


SURFACING LEGEND

5" CONCRETE WALK SPECIAL 3

5" CONCRETE WALK SPECIAL 4

NOTES

1. SEE CIVIL DRAWINGS FOR ROAD LAYOUT.
2. SEE ELECTRICAL DRAWINGS FOR LIGHTING DETAILS.
3. USE DETAIL 2/L10 FOR ALL LIGHT BASE COVERS.

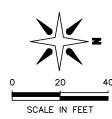

REVISIONS	DESCRIPTION	100% SUBMITTAL	ISSUED FOR BID				
	DATE	04/25/2014	06/10/2014				
certify that this plan, specification or report pared by me our under my direct supervision	to am a day registered condiscupe Architectuse laws of the state of Illinois.				24862 06/06/2014	LIC. # DATE	
certify that this plo	ne laws of the state			X	man lama	KREUN	

DRAWN: RLH
CHECKED: TK
APPROVED: TK

SHEET: L3

33RD AVENUE SOUTH BCS PHASE 2A INFRASTRUCTURE IMPROVEMENTS CITY PROJECT 2013-304 PROPOSED HOTEL PARKING 10.00 - 30.00' O.C. † 20.00' 10.75' O.C. † † 50 3.63' 1 1 1 _30.00' 0.c. + 30.00' 0.c. + 20.00' 4 +6 AST H LINE STATION SEE SHEET L3 00 **1** .00 BOULEVARD 5.00'7.50' 10.00'7.50'5.00' TYP. TYP. TYP. TYP. TYP. 02> TYP. 1+00 13+00 13-1700 W 98TH ST BLOOMINGTON MN 55431 PHONE (952) 563-8700 OSIUNG. ANCHIECTURE MASTER PLANNING ENVIRONMENTAL ASSOC. MATCH AMERICAN PROPOSED RESIDENTIAL EXISTING

LEGEND

♦ −EXISTING STREET LIGHT

KEYNOTES

CONCRETE CURB AND GUTTER DESIGN D418 SPECIAL 1 — SEE CIVIL

02 PLANTING BED

03 CONCRETE SIDEWALK

04 TRUNCATED DOMES - SEE CIVIL

CONCRETE CURB AND GUTTER DESIGN B618 SPECIAL 1 — SEE CIVIL

SURFACING LEGEND

4" CONCRETE WALK SPECIAL 1


CONCRETE WALK SPECIAL 2

5" CONCRETE WALK SPECIAL 3

5" CONCRETE WALK SPECIAL 4

NOTES

1. SEE CIVIL DRAWINGS FOR ROAD LAYOUT.
2. SEE ELECTRICAL DRAWINGS FOR LIGHTING DETAILS.
3. USE DETAIL 2/L10 FOR ALL LIGHT BASE COVERS.

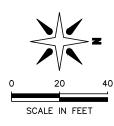


B 된 된

33RD AVENUE SOUTH STREE STREETSCAPE PLAN

DRAWN: RLH CHECKED: TK APPROVED: TK

SHEET: L4

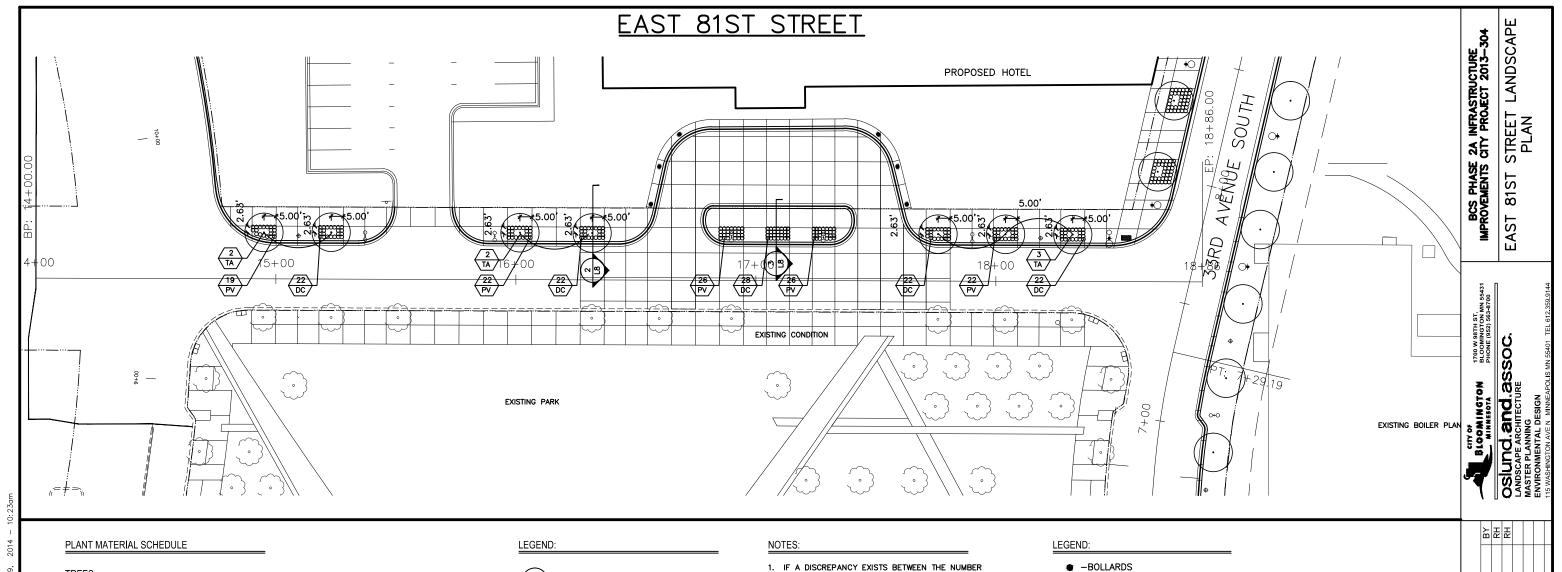

TREES

KEY COMMON\BOTANICAL NAME	QTY	' R001	S	IZE	REMARKS	
TA REDMOND LINDEN Tilia americana	7	В&В	3"	CAL.	MATCHED	SPECIMEN

PERENNIALS

KEY COMMON\BOTANICAL NAME	QTY	ROOT	SIZE	SPACING
PV SWITCHGRASS Panicum virgatum	112	CONT	#3	18" O.C.
DC TUFTED HAIR GRASS	116	CONT	#3	18" O.C.



- TREES



- PERENNIALS



- PLANT QUANTITY - PLANT KEY




- DETAIL KEY

- EXISTING TREE

- 1. IF A DISCREPANCY EXISTS BETWEEN THE NUMBER OF PLANTS SHOWN IN THE PLANT MATERIALS SCHEDULE AND THE PLANS, THE PLANS SHALL
- 2. RESTORE ALL AREAS DISTURBED BY CONSTRUCTION UNLESS NOTED OTHERWISE.
- 3. CONTRACTOR SHALL STAKE OUT LOCATION OF ALL PROPOSED TREES AND SHRUBS FOR APPROVAL BY LANDSCAPE ARCHITECT PRIOR TO CONSTRUCTION.
- 4. ALL PLANTED BEDS SHALL BE IRRIGATED. SEE IRRIGATION DRAWINGS.
- 5. ALL TREES TO BE TAGGED AT PLACE OF GROWTH BY LANDSCAPE ARCHITECT.
- 6. PLANTING BEDS SHALL HAVE MULCH MATERIAL TYPE 6.

- -STREET LIGHT (SEE ELECTRICAL)
- ⊕ −STREET LIGHT (SEE ELECTRICAL)
- ♦ -STREET LIGHT (SEE ELECTRICAL)

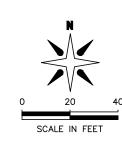


REVISIONS
DESCRIPTION
100% SUBMITTAL
ISSUED FOR BID DATE 04/25/2014 06/10/2014

DRAWN: RLH

CHECKED: TK APPROVED: TK

SHEET: L5

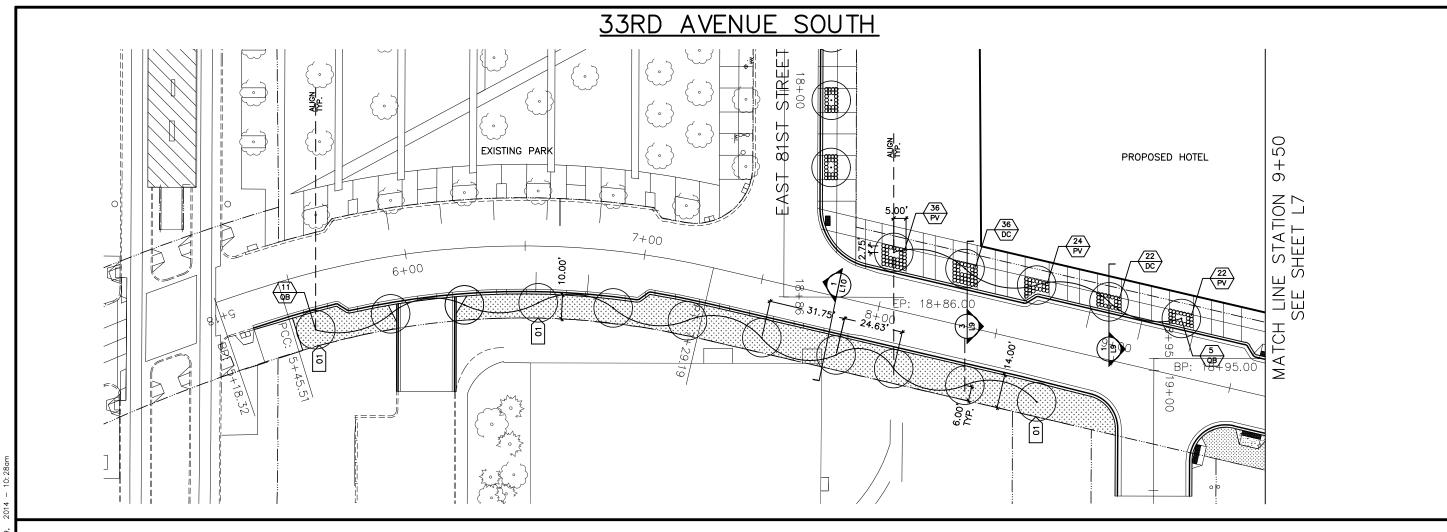

PLANT MATERIAL SCHEDULE

TREES

KEY COMMON\BOTANICAL NAME	QTYROOT	SIZE	REMARKS
QB SWAMP WHITE OAK Quercus bicolor	16 B&B	3" CAL.	MATCHED SPECIMEN

PERENNIALS

KEY COMMON\BOTANICAL NAME	QTY	ROOT	SIZE	SPACING
PV SWITCHGRASS Panicum virgatum	82	CONT	#3	18" O.C.
DC TUFTED HAIR GRASS Deschampsia cespitosa	58	CONT	#3	18" O.C.

LEGEND:



0

- TREES



- PERENNIALS - PLANT QUANTITY





- EXISTING TREE




- MULCH MATERIAL TYPE 9

KEYNOTES:

01 - STEEL LANDSCAPE EDGER

NOTES:

- 1. IF A DISCREPANCY EXISTS BETWEEN THE NUMBER OF PLANTS SHOWN IN THE PLANT MATERIALS SCHEDULE AND THE PLANS, THE PLANS SHALL
- RESTORE ALL AREAS DISTURBED BY CONSTRUCTION UNLESS NOTED OTHERWISE.
- CONTRACTOR SHALL STAKE OUT LOCATION OF ALL PROPOSED TREES AND SHRUBS FOR APPROVAL BY LANDSCAPE ARCHITECT PRIOR TO CONSTRUCTION.
- 4. ALL PLANTED BEDS AND SODDED AREAS SHALL BE IRRIGATED. SEE IRRIGATION DRAWINGS.
- 5. ALL TREES TO BE TAGGED AT PLACE OF GROWTH BY LANDSCAPE ARCHITECT.
- 6. PLANTING BEDS SHALL HAVE MULCH MATERIAL TYPE 6.

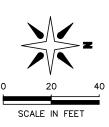

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BCS PHASE 2A INFRASTRUCTURE IMPROVEMENTS CITY PROJECT 2013-304

1700 W 98TH ST BLOOMINGTON MN 55431 PHONE (952) 563-8700


OSIUNCIAN BHONE
LANDSCAPE ARCHITECTURE
MASTER PLANNING
ENVIRONMENT

AVENUE SOUTH STREE LANDSCAPE PLAN

DRAWN: RLH CHECKED: TK APPROVED: TK

SHEET: L6

33RD AVENUE SOUTH

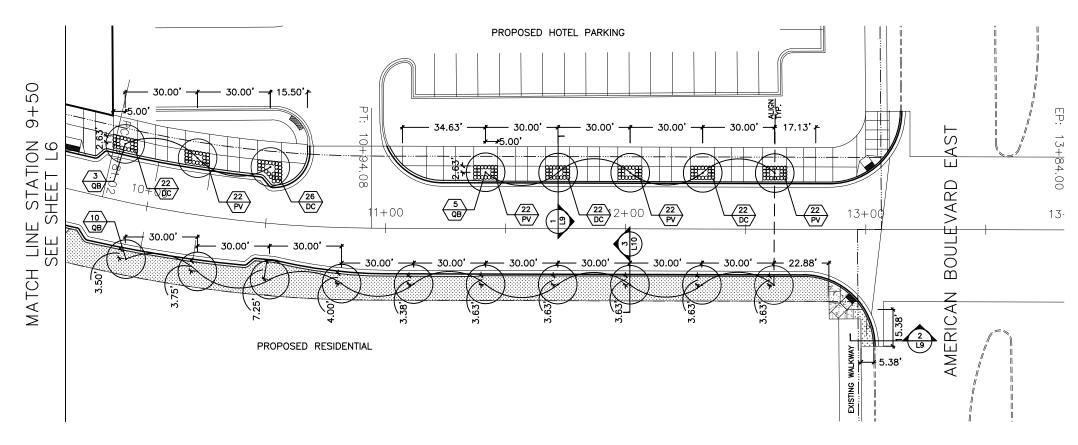

PLANT MATERIAL SCHEDULE

KEY	COMMON\BOTANICAL NAME	QTY	ROOT	SIZE	SPACING
PV	SWITCHGRASS Panicum virgatum	88	CONT	#3	18" O.C.
DC	TUFTED HAIR GRASS	92	CONT	#3	18" O.C.

LEGEND:



- EXISTING TREES



PERENNIALS



- PLANT QUANTITY - PLANT KEY



- DETAIL KEY



- SODDING TYPE SALT TOLERANT

NOTES:

- 1. IF A DISCREPANCY EXISTS BETWEEN THE NUMBER OF PLANTS SHOWN IN THE PLANT MATERIALS SCHEDULE AND THE PLANS, THE PLANS SHALL
- RESTORE ALL AREAS DISTURBED BY CONSTRUCTION UNLESS NOTED OTHERWISE.
- 3. CONTRACTOR SHALL STAKE OUT LOCATION OF ALL PROPOSED SHRUBS FOR APPROVAL BY LANDSCAPE ARCHITECT PRIOR TO CONSTRUCTION.
- 4. ALL PLANTED BEDS AND SODDED AREAS SHALL BE IRRIGATED. SEE IRRIGATION DRAWINGS.
- 5. PLANTING BEDS SHALL HAVE MULCH MATERIAL TYPE 6.



BCS PHASE 2A INFRASTRUCTURE IMPROVEMENTS CITY PROJECT 2013-304

1700 W 98TH ST BLOOMINGTON MN 55431 PHONE (952) 563-8700

OSIUNG. and. assoc LANDSCAPE ARCHITECTURE MASTER PLANNING ENVIRONMENTAL DESIGN

일목된

REVISIONS
DESCRIPTION
100% SUBMITTAL
ISSUED FOR BID

AVENUE SOUTH STREE LANDSCAPE PLAN


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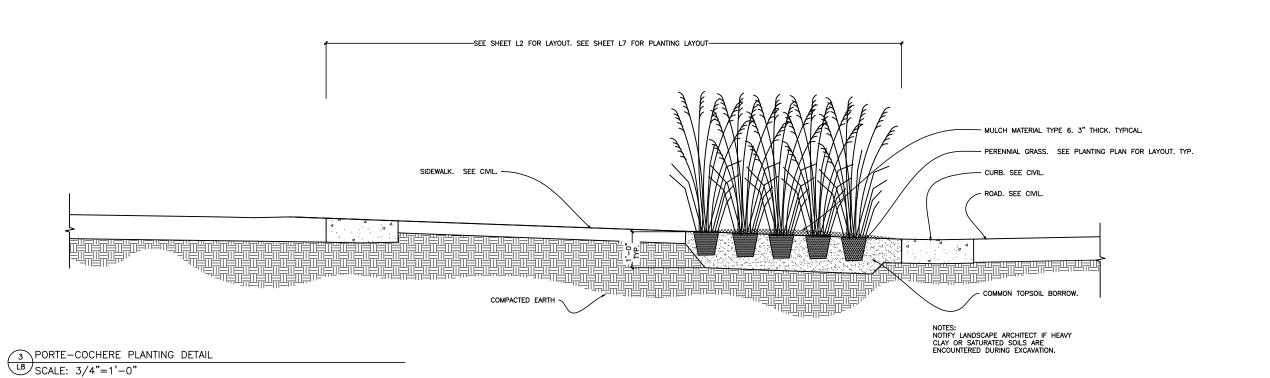
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CHECKED: TK SHEET:

SCALE IN FEET

PERENNIALS



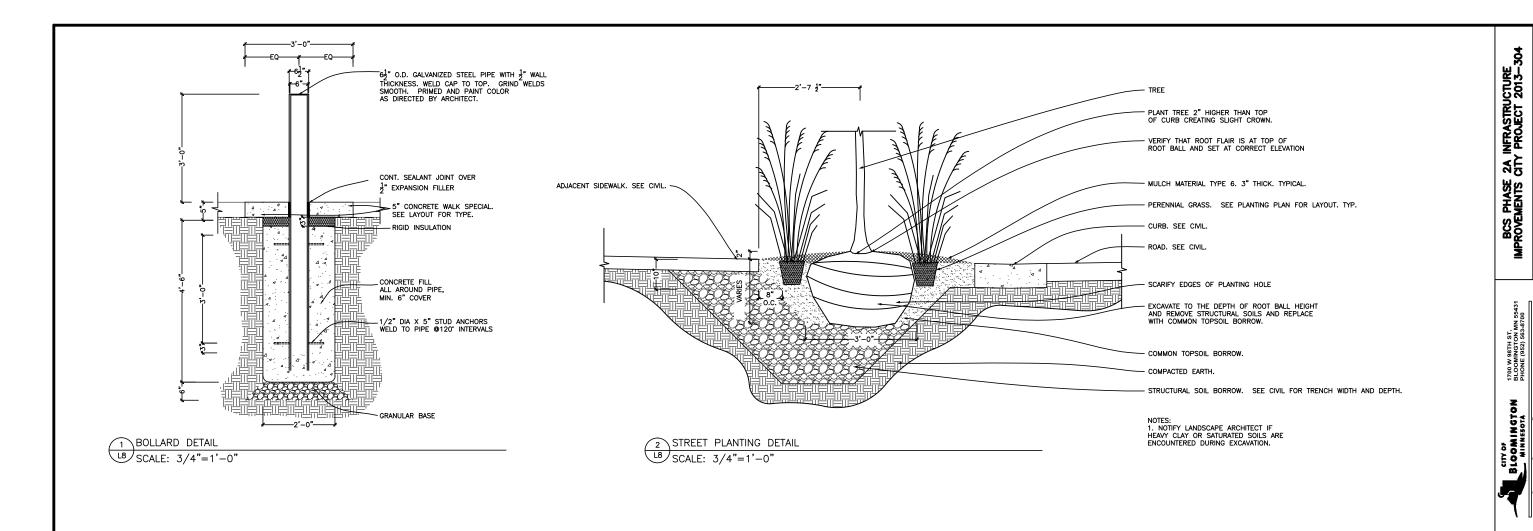


CHECKED: TK APPROVED: TK SHEET:

L8

DETAILS

OSIUMC. and assoc.
LANDSCAPE ARCHITECTURE
BANGER PLANNING
ENVIRONMENTAL DESIGN

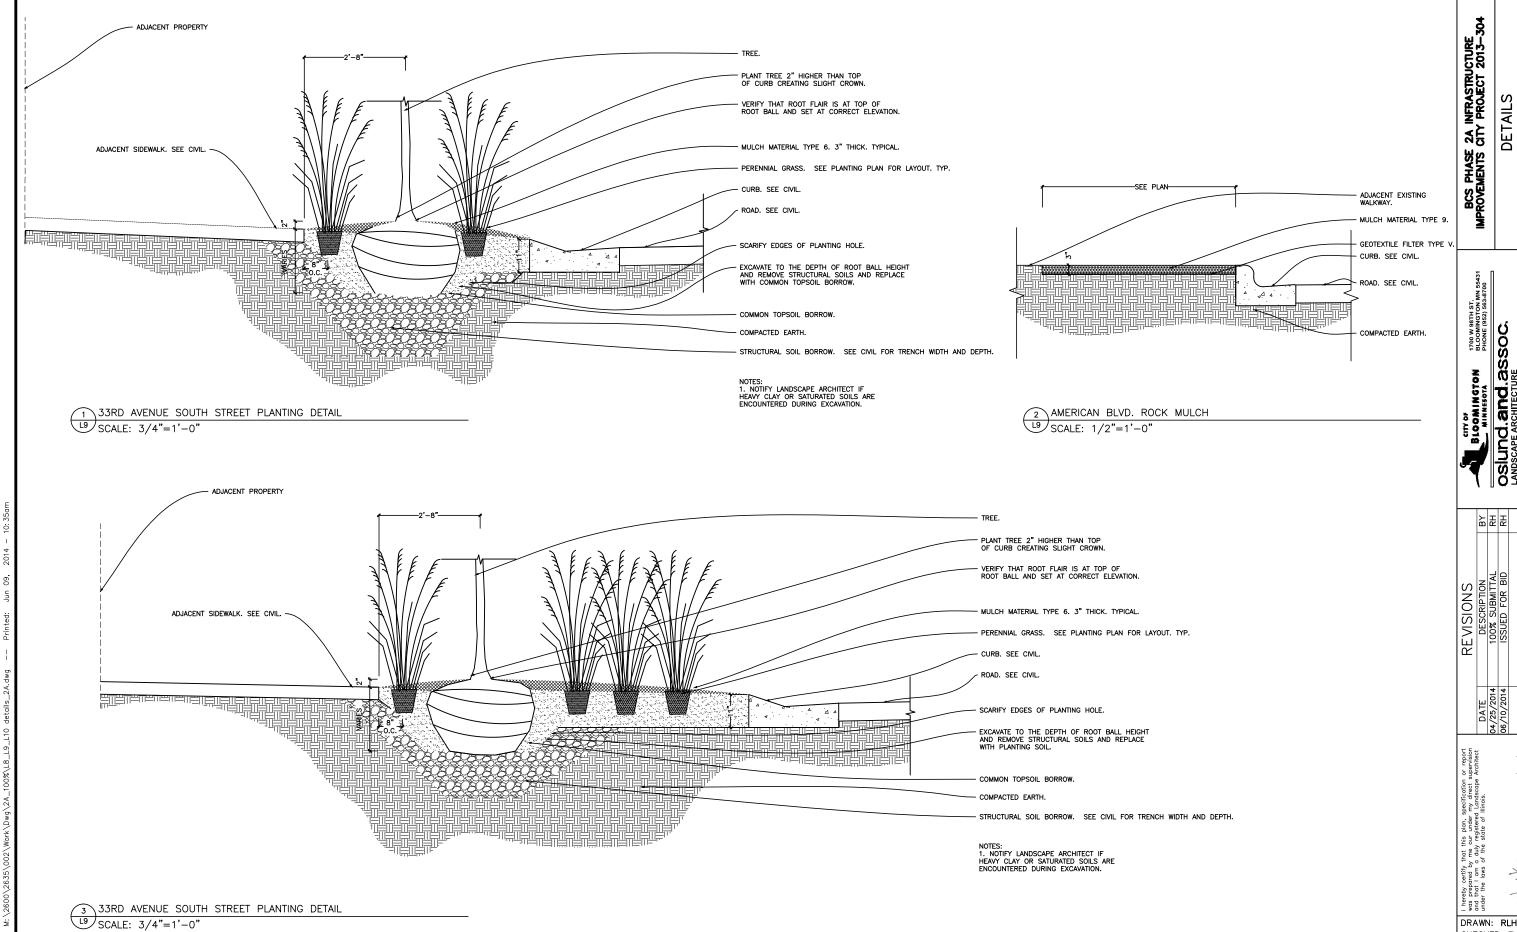

OSIUNCI and assoc.
LANDSCAPE ARCHITECTURE
BUNIRONMENTAL DESIGN

일목된 REVISIONS
DESCRIPTION
100% SUBMITTAL
ISSUED FOR BID

DRAWN: RLH CHECKED: TK APPROVED: TK


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L9

____ {" CHAMFER - ₹" SS INSERT — ∰" REBAR - 1" CHAMFER TOP VIEW (BOTH HALVES) 1" CHAMFER 1" DIA HOLE ¹/₈"JOINT TAPERED TO 3"

¹ CHAMFER

1" REBAR

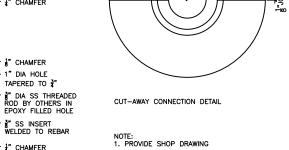

SECTION VIEW

2 LIGHT BASE COVER DETAIL SCALE: 3/2"=1'-0"

- TREE PLANT TREE 2" HIGHER THAN TOP OF CURB CREATING SLIGHT CROWN. -SEE PLAN FOR LAYOUT DIMENSION.-CONTINUE NEW TURF TO MEET VERIFY THAT ROOT FLAIR IS AT TOP OF ROOT BALL AND SET AT CORRECT ELEVATION EXISTING TURF/PLANTINGS. PULL MULCH AWAY FROM TREE TRUNK. COMMON TOPSOIL BORROW 3" MULCH MATERIAL TYPE 6. SODDING TYPE SALT TOLERANT. - CURB. SEE CIVIL. - ROAD, SEE CIVIL. SCARIFY EDGES OF PLANTING HOLE - EXCAVATE TO THE DEPTH OF ROOT BALL HEIGHT. COMPACTED EARTH STRUCTURAL SOIL BORROW. SEE CIVIL FOR TRENCH WIDTH AND DEPTH. NOTES:
1. NOTIFY LANDSCAPE ARCHITECT IF HEAVY
CLAY OR SATURATED SOILS ARE ENCOUNTERED DURING EXCAVATION.
2. SLOPE TURF AWAY FROM TREE AT 2% SLOPE.

일목된 REVISIONS
DESCRIPTION
100% SUBMITTAL
ISSUED FOR BID I hereby certify that this plan, specification or report ass prepared by me our under my direct supervision and that I am a duly registered Landscape Architect under the laws of the state of Illinois.

BCS PHASE 2A INFRASTRUCTURE IMPROVEMENTS CITY PROJECT 2013—304

1700 W 98TH ST BLOOMINGTON MN 55431 PHONE (952) 563-8700

BLOOMINGTON MINNESOTA


OSIUNCI and assoc.
LANDSCAPE ARCHITECTURE
BUNIRONMENTAL DESIGN

DETAILS

DRAWN: RLH CHECKED: TK APPROVED: TK

SHEET: L10

3 33RD AVENUE SOUTH STREET TREE/TURF DETAIL SCALE: 1/2"=1'-0"

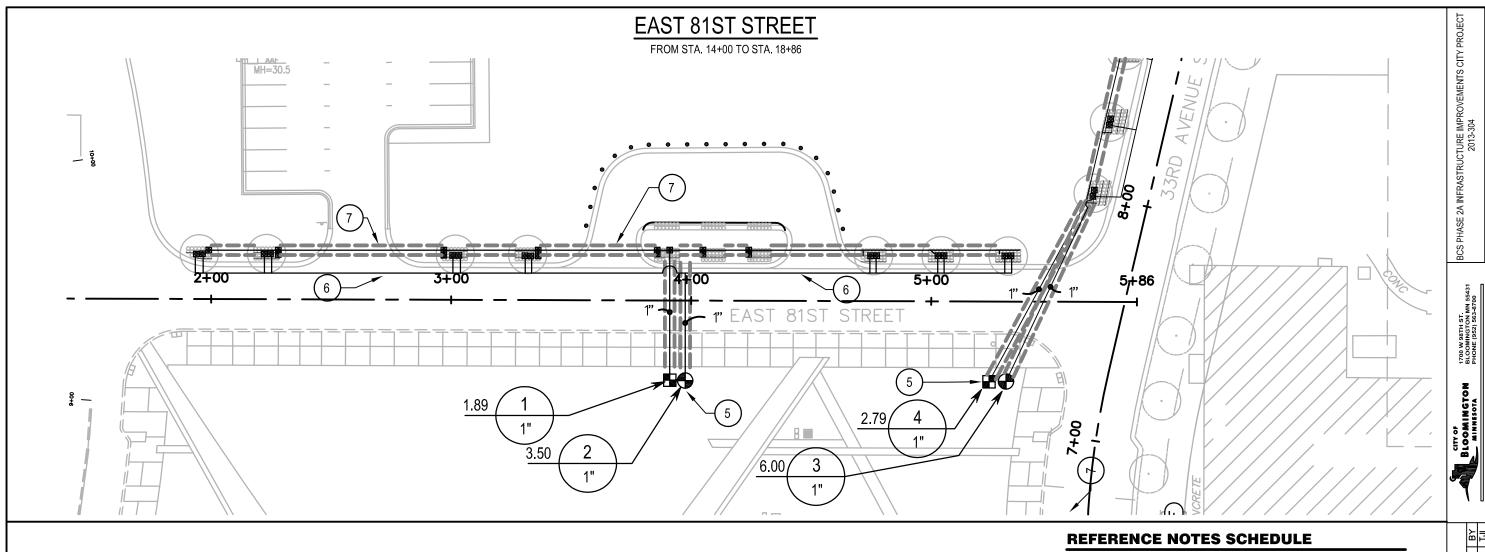

IRRIGATION SCHEDULE

<u>SYMBOL</u>

MANUFACTURER/MODEL/DESCRIPTION

LST RST SST

Hunter MP Strip PROS-04-CV
Turf Rotator, 4" (10.16 cm) pop-up with factory
installed check valve, pressure regulated to 40
psi (2.76 bar), MP Rotator nozzle on PRS40
body. LST=Ivory left strip, SST=Brown side strip,
RST=Copper right strip.

Hunter RZNS-36-25CV 36" long RZNS with installed 0.25 GPM bubbler, Check Valve, 1/2" swing joint for connection to 1/2" pipe

SYMBOL

MANUFACTURER/MODEL/DESCRIPTION

Rain Bird XCZ-100-PRB-COM
Medium Plus Flow Drip Control Kit for Commercial
Applications. I" Ball Valve with I" PESB Valve
and I" Pressure Regulating 40psi Quick-Check
Basket Filter. 3gpm to 20gpm.



Area to Receive Dripline
Hunter PLD-04-18 (18)
In-Line Pressure Compensating Landscape
Dripline with Built-in Check Valve. 0.46PH
emitters at 18.0" O.C. Dripline laterals spaced
at 18.0" apart, with emitters offset for triangular
pattern. UV Resistant.

SYMBOL MANUFACTURER/MODEL/DESCRIPTION

Hunter IC

Hunter ICV-6

1", 1-1/2", 2", and 3" Plastic Electric Remote
Control Valves, Globe Configuration, with NPT
Threaded Inlet/Outlet, for Commercial/Municipal
Use.

₿F

Febco 825Y 2"

Reduced Pressure Backflow Preventer

M

Water Meter 3"

Irrigation Lateral Line: Polyethylene and PVC Class 160 Polyethylene SDR-7 up to 1-1/4, then PVC Class 160 SDR 26 for 1-1/2" and larger. Only lateral transition pipe sizes 1 1/4" and above are inclated on the plan, with all others being 1" in size.

Irrigation Mainline: HDPE PE3408 DR II 160psi
Pipe Sleeve: PVC Class 200 SDR 21

Valve Callout

Valve Number

Valve Flow

Valve Size

SYMBOL DESCRIPTION

(1) IRRIGATION CONTRACTOR TO REMOVE EXISTING
CONNECTION EQUIPMENT (BACKFLOW, METER,
ENCLOSURE) FROM THIS APPROXIMATE LOCATION.

2 LOCATION OF NEW CONNECTION POINT. IRRIGATION CONTRACTOR TO SUPPLY NEW 3" METER, BACKFLOW AND ENCLOSURE AT THIS LOCATION - FIELD VERIFY.

IRRIGATION CONTRACTOR TO MAINTAIN TWO-WIRE PATH FROM EXISTING TORO SENTINEL CONTROLLER (BASELINE DECODER INTERFACE) ACCROSS 33RD AVENUE DURING CONSTRUCTION. COORDINATE PLACEMENT/PROTECTION OF TWO-WIRE PATH WITH ALL ASSOCIATED TRADES.

(4) IRRIGATION CONTRACTOR TO ESTABLISH NEW TEMPORARY WATER CONNECTION (METER, BACKFLOW) FROM HYDRANT AT THIS APPROXIMATE LOCATION - FIELD VERIFY. CONNECT TEMPORAY WATER SOURCE TO EXISTING 4" MAIN LINE AT THIS APPROXIMATE LOCATION.

(5) INSTALL NEW VALVES FOR PHASE 2A ON EXISTING MAIN LINE AT THIS APPROXIMATE LOCATION - FIELD VERIFY. CONNECT NEW VAVLES TO EXISTING TWO-WIRE PATH AND CONNECT WITH COMPATIBLE BASELINE DECODERS.

6 PIPING SHOWN OUTSIDE OF LANDSCAPE/TURF AREA FOR CLARITY ONLY. PLACE ALL IRRIGATION EQUIPMENT IN LANDSCAPE/TURF AREAS.

PLACE 2 - 4" PVC SCHEDULE 40 SLEEVE AND 1 - 1 1/2" PVC SCHEDULE 40 SLEEVE BETWEEN ALL PLANTING AREAS AND AT ALL ROAD/SIDEWALK CROSSINGS - TYPICAL. COORDINATE PLACEMENT OF SLEEVING WITH ALL ASSOCIATED TRADES.

REVISIONS	DESCRIPTION	100%SUBMITTAL	ISSUED FOR BID			
	DATE	04/25/2014	06/10/2014			
BY ME OR ULY	WS OF				DATE	

IRRIGA⁻

81S

لبا

STREET PLAN 14+00 TO 8


I HEREBY CERTIFY THAT THIS PLAN WAS PREPARED BY ME OR UNDER MY DIRECT SUPERVISION AND THAT I AM A DULY LICENSED PROFESSIONAL ENGINEER UNDER THE LAWS OF THE STATE OF MINNESOTA. LIC. # DATE					
I HEREBY CERTIFY THAT THIS PLAN WAS PREARED UNDER MY DIRECT SUPERVISION AND THATT ANA A DILCENSED PROFESSIONAL ENGINEER UNDER THE LATHE STATE OF MINNESOTA.	BY ME OR ULY	WS OF		DATE	
I HEREBY CERTIFY THAT THIS PLAN WAS UNDER MY DIRECT SUPERVISION AND THE LICENSED PROFESSIONAL ENGINEER UNTHE STATE OF MINNESOTA.	PREPARED IAT I AM A D	DER THE LA		HC. #	
=53F	EREBY CERTIFY THAT THIS PLAN WAS! DER MY DIRECT SUPERVISION AND TH	ENSED PROFESSIONAL ENGINEER UNI E STATE OF MINNESOTA.			
	_ ^	⊣ ⊢			

DRAWN: CMR
CHECKED: JWR
APPROVED: JWR

SHEET:

I1 of I5



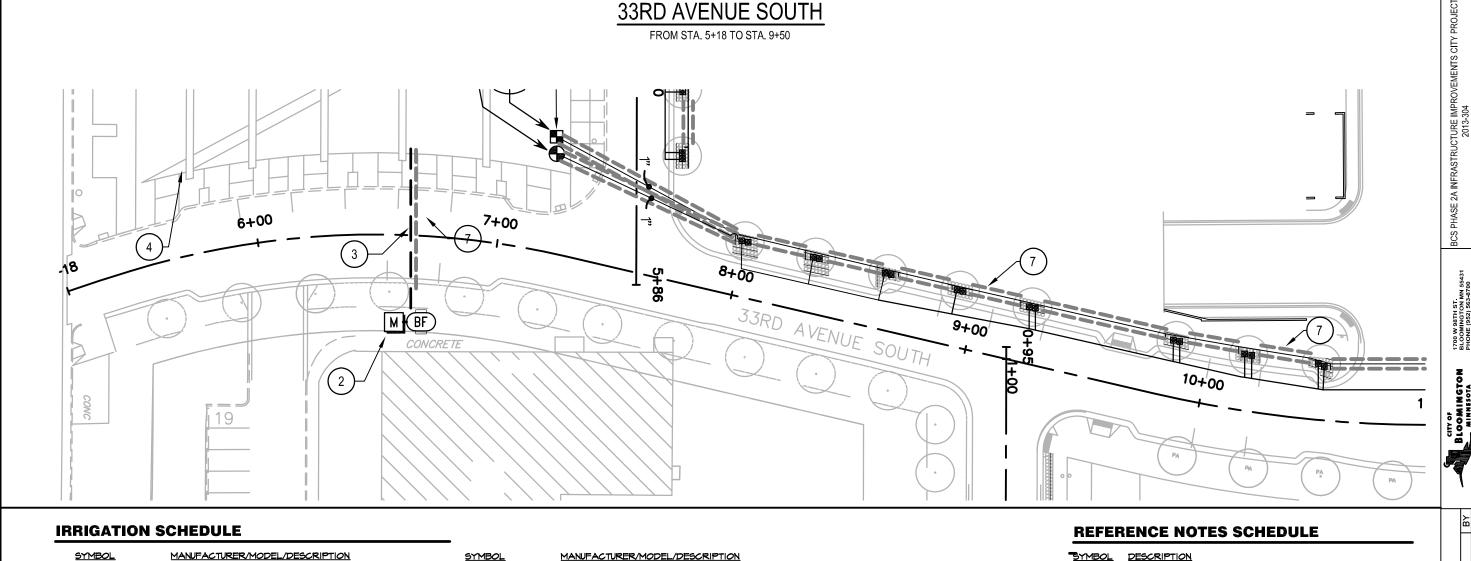

B B C LST RST SST

Hunter MP Strip PROS-04-CV

Turf Rotator, 4" (10.16 cm) pop-up with factory installed check valve, pressure regulated to 40 psi (2.76 bar), MP Rotator nozzle on PRS40 body. LST=Ivory left strip, SST=Brown side strip, RST=Copper right strip.

Hunter RZMS-36-25CV 36" long RZMS with installed 0.25 GPM bubbler, Check Valve, I/2" swing joint for connection to

SYMBOL

MANUFACTURER/MODEL/DESCRIPTION

Rain Bird XCZ-100-PRB-COM Medium Plus Flow Drip Control Kit for Commercial Applications. I" Ball Valve with I" PESB Valve and I" Pressure Regulating 40psi Quick-Check Basket Filter. 3gpm to 20gpm.



Area to Receive Dripline Hunter PLD-04-18 (18) In-Line Pressure Compensating Landscape Dripline with Built-In Check Valve. 0.46PH emitters at 18.0" O.C. Dripline laterals spaced at 18.0" apart, with emitters offset for triangular pattern. UV Resistant.

1

I", I-I/2", 2", and 3" Plastic Electric Remote Control Valves, Globe Configuration, with NPT Threaded Inlet/Outlet, for Commercial/Municipal

Œ

Febco 825Y 2" Reduced Pressure Backflow Preventer

M

Water Meter 3"

Irrigation Lateral Line: Polyethylene and PVC Class 160 Polyethylene SDR-7 up to 1-1/4, then PVC Class 160 SDR 26 for 1-1/2" and larger. Only lateral transition pipe sizes | 1/4" and above are indicated on the plan, with all others being I" in

Irrigation Mainline: HDPE PE3408 DR II 160psi

Pipe Sleeve: PVC Class 200 SDR 21 Valve Callout Valve Number #1 Valve Flow Valve Size

① IRRIGATION CONTRACTOR TO REMOVE EXISTING CONNECTION EQUIPMENT (BACKFLOW, METER, ENCLOSURE) FROM THIS APPROXIMATE LOCATION.

2 LOCATION OF NEW CONNECTION POINT. IRRIGATION CONTRACTOR TO SUPPLY NEW 3" METER, BACKFLOW AND ENCLOSURE AT THIS LOCATION - FIELD VERIFY.

3 IRRIGATION CONTRACTOR TO MAINTAIN TWO-WIRE PATH FROM EXISTING TORO SENTINEL CONTROLLER (BASELINE DECODER INTERFACE) ACCROSS 33RD AVENUE DURING CONSTRUCTION. COORDINATE PLACEMENT/PROTECTION OF TWO-WIRE PATH WITH ALL ASSOCIATED TRADES.

4 IRRIGATION CONTRACTOR TO ESTABLISH NEW TEMPORARY WATER CONNECTION (METER, BACKFLOW) FROM HYDRANT AT THIS APPROXIMATE LOCATION -FIELD VERIFY. CONNECT TEMPORAY WATER SOURCE TO EXISTING 4" MAIN LINE AT THIS APPROXIMATE LOCATION.

5 INSTALL NEW VALVES FOR PHASE 2A ON EXISTING MAIN LINE AT THIS APPROXIMATE LOCATION - FIELD VERIFY. CONNECT NEW VAVLES TO EXISTING TWO-WIRE PATH AND CONNECT WITH COMPATIBLE BASELINE DECODERS.

6 PIPING SHOWN OUTSIDE OF LANDSCAPE/TURF AREA FOR CLARITY ONLY. PLACE ALL IRRIGATION EQUIPMENT IN LANDSCAPE/TURF AREAS.

PLACE 2 - 4" PVC SCHEDULE 40 SLEEVE AND I - I I/2" PVC SCHEDULE 40 SLEEVE BETWEEN ALL PLANTING AREAS AND AT ALL ROAD/SIDEWALK CROSSINGS -TYPICAL. COORDINATE PLACEMENT OF SLEEVING WITH ALL ASSOCIATED TRADES.

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TION

IRRIGA.

AVENUE

3RD

SOUTH PLAN 5+18 TO ST.

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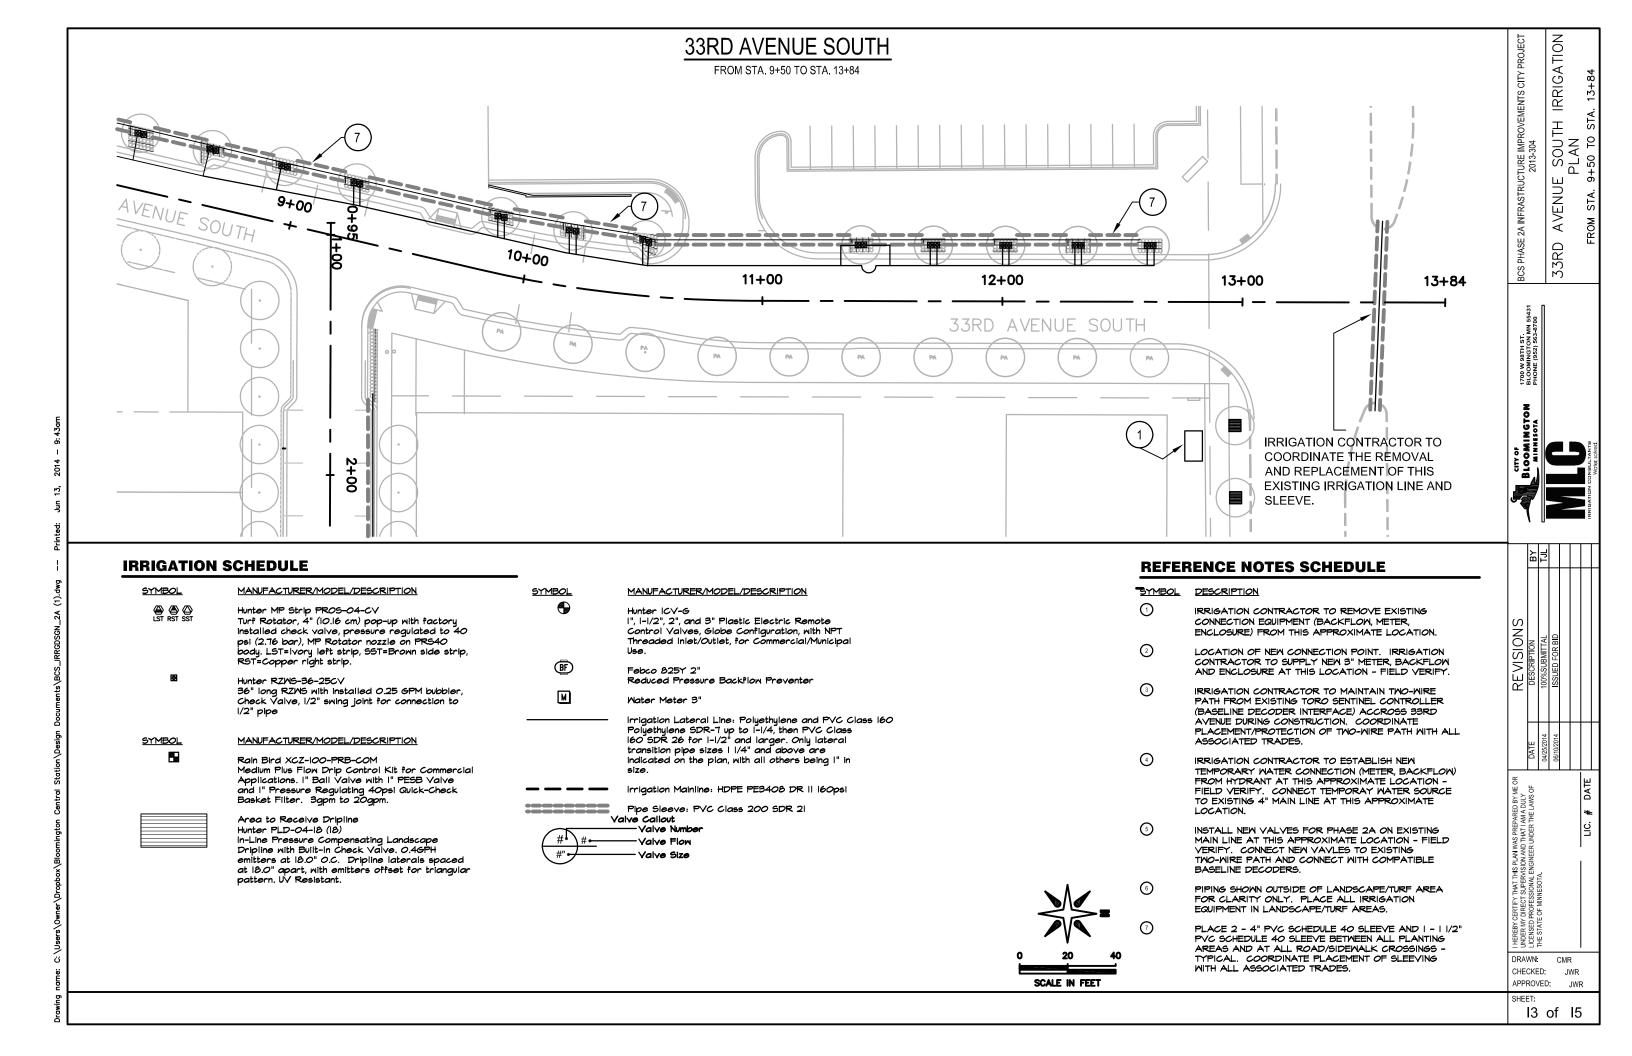
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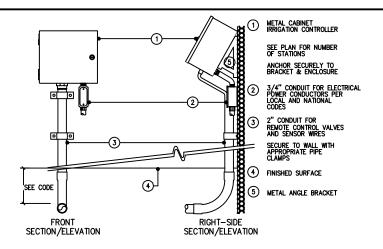
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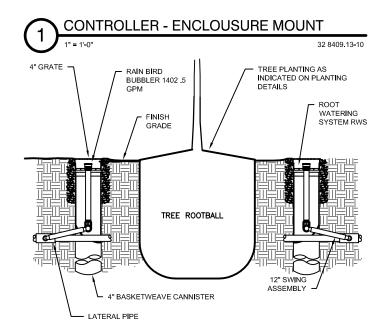
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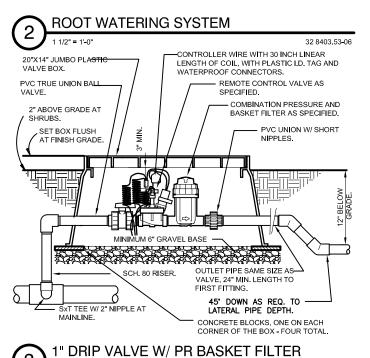
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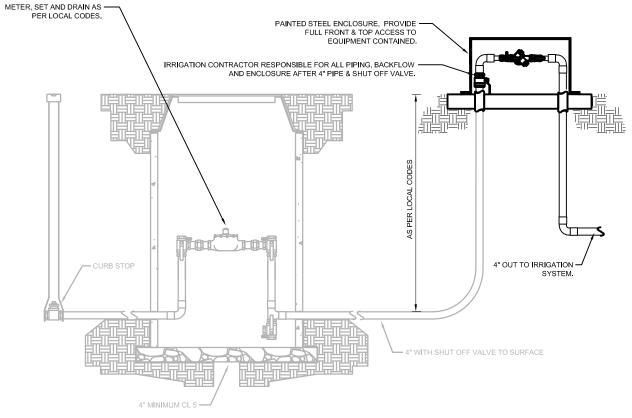






32 8413.76-30

TOP VIEW



GENERAL NOTES:

- ALL WORK TO BE AS PER LOCAL CODE

 ENCLOSURE SHALL HAVE ACCESS VIA TOP AND FRONT PANELS. ENSLOSURE SHALL BE LOCKABLE WITH INTERNAL
- 3. SEE CIVIL PLANS FRO WATER CONNECTION DETAIL.



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SCS PHASE 2 INFRASTRUCTURE IMPROVEMENTS CITY PROJECTS 2013-305 DE.

IRRIGATION


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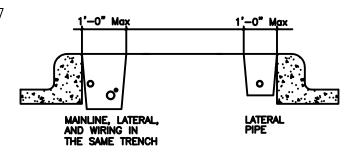
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TORO DL-MP9 OPERATION INDICATOR TOP OF MULCH LANDSCAPE DRIP LINE AS PER SPECIFICATIONS - BURIED A MINIMUM OF 4" IN APPROVED BACKFILL

NOTES:

PLACE SLEEVING BELOW ALL HARDSCAPE ELEMENTS

MINIMUM OF CLASS 200 PVC SLEEVING MATERIAL SLEEVES SHALL BE A MINIMUM OF TWO SIZES LARGER

PLACE IRON POST AT EACH END OF SLEEVING FOR LOCATION PURPOSES

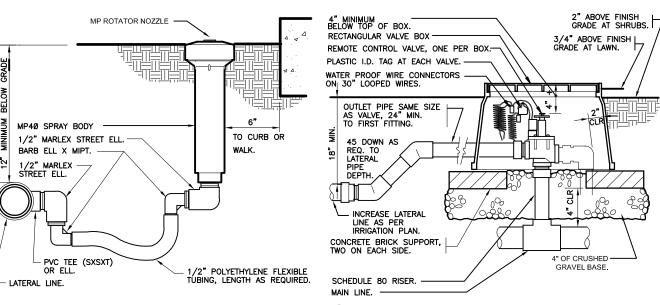PLACE WIRE IN SEPARATE 1" (MIN) SLEEVE

NOTES:

PLACE ONE PER DRIP LINE ZONE. PLACE TOWARDS "FLUSH END" OF

3. PLACE IN AREA OF HIGH VISIBILITY.

TURF ROTARY - FLEX PIPE

REMOTE CONTROL VALVE - GRAVEL BASE 32 8406.13-10 1 1/2" = 1'-0

5. WHEN ELEVATION CHANGE IS 10 FT OR MORE, ZONE THE BOTTOM ON A SEPARATE VALVE.

PIPE PLACEMENT @ BLVD'S 1/4" = 1'-0"

DOGBONE SHAPED

TORO OPERATION INDICATOR

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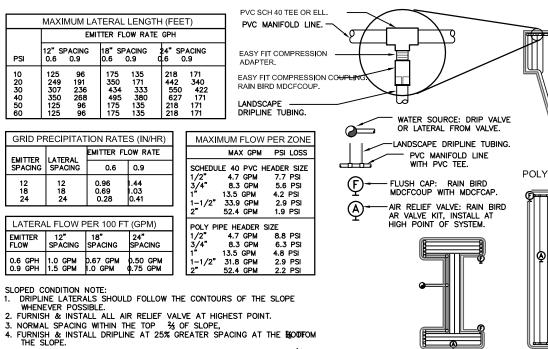
ICS PHASE 2 INFRASTRUCTURE IMPROVEMENTS CITY 2013-304 & 2013-305


1700 W 98TH ST. BLOOMINGTON N PHONE (952) 563-

DE

GATION

TYPICAL OFFSET 2" FROM HARDSCAPE, 4" FROM PLANTED AREA PVC MAINLINE. TYPICAL FPT ADAPTER AND COMPRESSION COUPLER. DRIP VALVE / FILTER / REGULATOR. 3/4" PVC LATERAL TYPICAL OFFSET 2" FROM HARDSCAPE, 4" POLYETHYLENE OR PVC HEADER MANIFOLD, SIZE AS PER "MAXIMUM FROM PLANTED FLOW PER ZONE" CHART. AREA. COMPRESSION DRIPLINE SPACING AS NOTED. EMITTERS MAXIMUM LENGTH OF ATERAL, SEE CHART OFFSET FOR TRIANGULAR SPACING. AIR RELIEF VALVE AT MAXIMUM LENGTH OF LATERAL, SEE CHART. HIGH POINT, AS INDICATED. TYPICAL DRIP LINE-WITH EMITTER SPACING AS NOTED. TIE DOWN STAKE AT ALL TEES, ELLS, AND AT 4' O.C. AT CLAY, 3' O.C. AT LOAM, OR 2' O.C. AT SAND. - FLUSH VALVE OR — CAP AT LOW END, AS NOTED. END FEED EXAMPLE CENTER FEED EXAMPLE



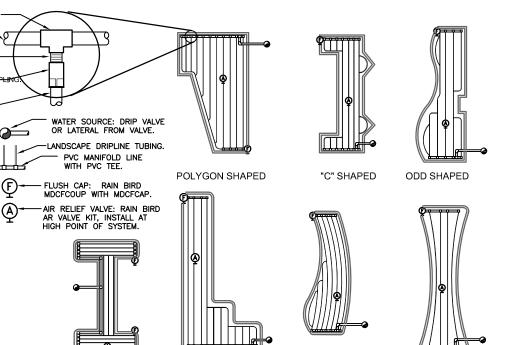

CURVED POLYGON

CORNER SHAPED

32 8409.76-1

TYPICAL RAIN BIRD DRIPLINE REQUIREMENTS

5

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HOURGLASS SHAPED

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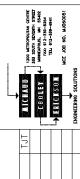
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15 of 15

ELE	CTRICAL DRAWING INDEX							
DRAWING NO.	RAWING NO. DRAWING TITLE							
E1	ELECTRICAL TITLE SHEET, SHEET INDEX AND SYMBOLS							
E2	ELECTRICAL SALVAGE PLAN — EXISTING 33RD AVE SOUTH							
E3	ELECTRICAL LIGHTING PLAN — EXISTING 33RD AVE SOUTH							
E4	ELECTRICAL LIGHTING PLAN — EAST 81ST STREET							
E5	ELECTRICAL LIGHTING PLAN — 33RD AVE SOUTH							
E6	ELECTRICAL LIGHTING PLAN - 33RD AVE SOUTH							
E7	ELECTRICAL POWER PLAN - EAST 81ST STREET							
E8	ELECTRICAL POWER PLAN - 33RD AVE SOUTH							
E9	ELECTRICAL POWER PLAN - 33RD AVE SOUTH							
E10	E10 ELECTRICAL DETAILS AND SCHEDULES							
E11 ELECTRICAL WIRING DIAGRAMS, DETAILS AND SCHEDULES								
E12 ELECTRICAL WIRING DIAGRAMS AND DETAILS								
E13	E13 ELECTRICAL WIRING DIAGRAMS							
E14	EAST 81ST STREET LIGHTING							
E15	33RD AVENUE SOUTH STREET LIGHTING							
E16 LIGHITNG TABULATION								

SHEET, SYMBOLS BCS PHASE 2A INFRASTRUCTURE IMPROVEMENTS CITY PROJECT 2013-. TITLE AND CTRICAL T INDEX ELE(SHEE⁻

BLOOMINGTON




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I HEREBY CERTIFY THAT THIS PLAN WAS PREPARED BY ME OR UNDER MY DIRECT SUPERVISION AND THAT I AM A DULY LICENSED PROFESSIONAL ENGINEER UNDER THE LAWS OF THE STATE OF MINNESOTA.


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SHEET:

E1 OF 83




- B. ALL EQUIPMENT, DEVICES, AND LIGHTS INDICATED ON PLAN WERE TAKEN FROM EXISTING PLANS AND/OR FIELD OBSERVATION, AND SHALL NOT BE CONSIDERED 100% ACCURATE. THE ELECTRICAL CONTRACTOR IS RESPONSIBLE FOR FIELD VERIFYING EXISTING SYSTEMS PRIOR TO BIDDING. NOTIFY THE ENGINEER OF ANY DISCREPANCIES WHICH MAY AFFECT THE WORK UNDER THIS CONTRACT.
- C. VERIFY EXACT CONDITIONS PRIOR TO ANY WORK. ELECTRICAL CONTRACTOR SHALL MAINTAIN CONTINUITY OF ADJACENT CIRCUITS THAT REMAIN TO DOWNSTREAM DEVICES/EQUIPMENT. RE-ROUTE CONDUIT AND WIRING AS NECESSARY.
- D. DEVICES AND EQUIPMENT SHOWN LIGHT ARE EXISTING TO REMAIN. DEVICES AND EQUIPMENT SHOWN DARK AND DASHED ARE TO BE SALVAGED, REFER TO NEW LIGHTING PLAN FOR LOCATIONS.
- E. REFER TO MNDOT STANDARD SPECIFICATIONS FOR CONSTRUCTION 2014 EDITION.
- F. ELECTRICAL CONTRACTOR TO COORDINATE ALL ELECTRICAL SITE WORK WITH CIVIL, ARCHITECTURAL, AND MECHANICAL DRAWINGS, AS WELL AS EXISTING SITE CONDITIONS, PRIOR TO INSTALLATION.

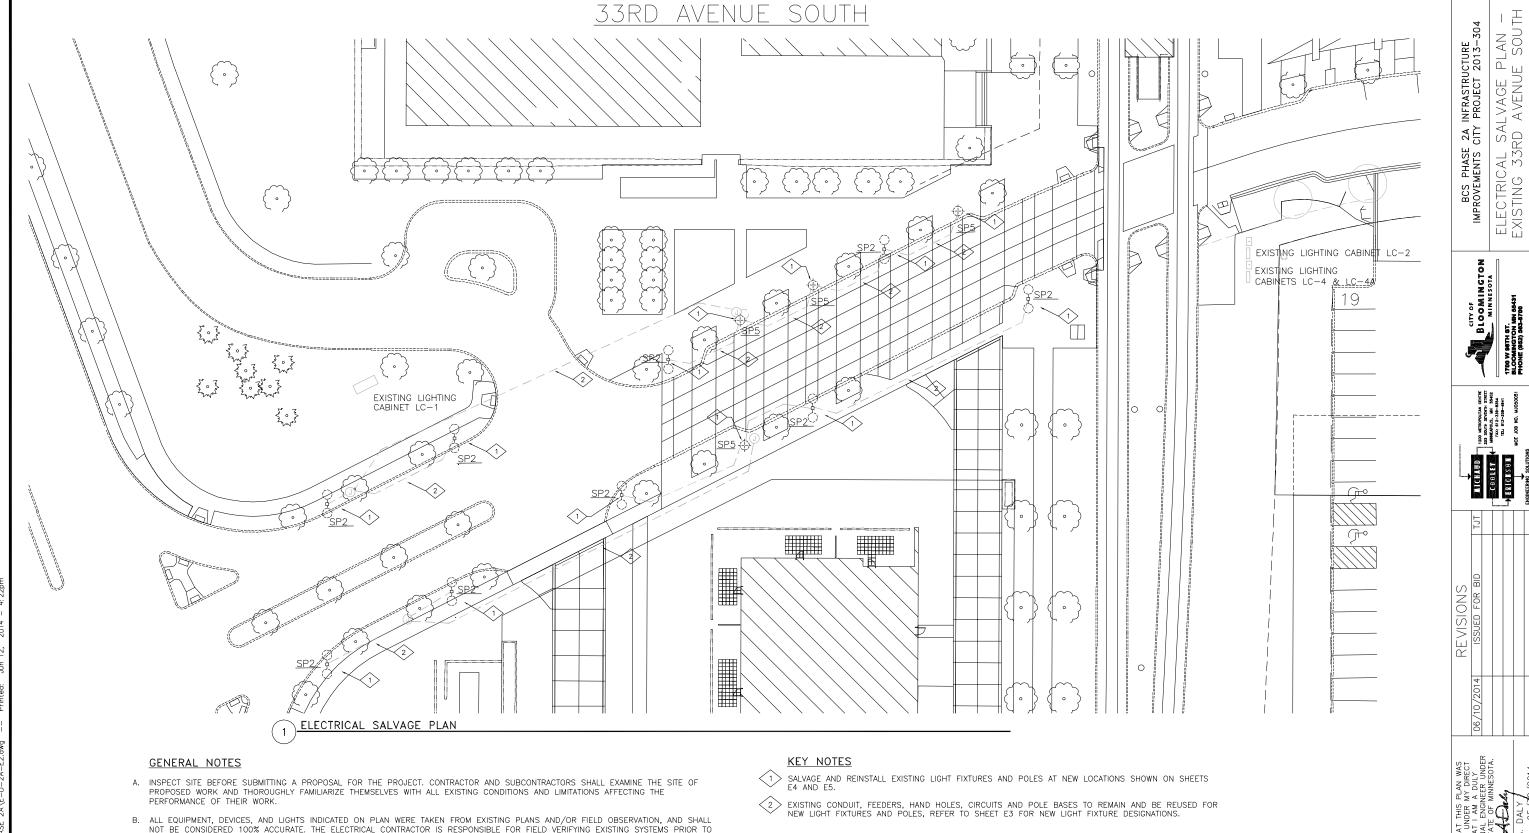

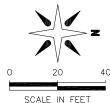SCALE IN FEET


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SHEET: E2 OF 83

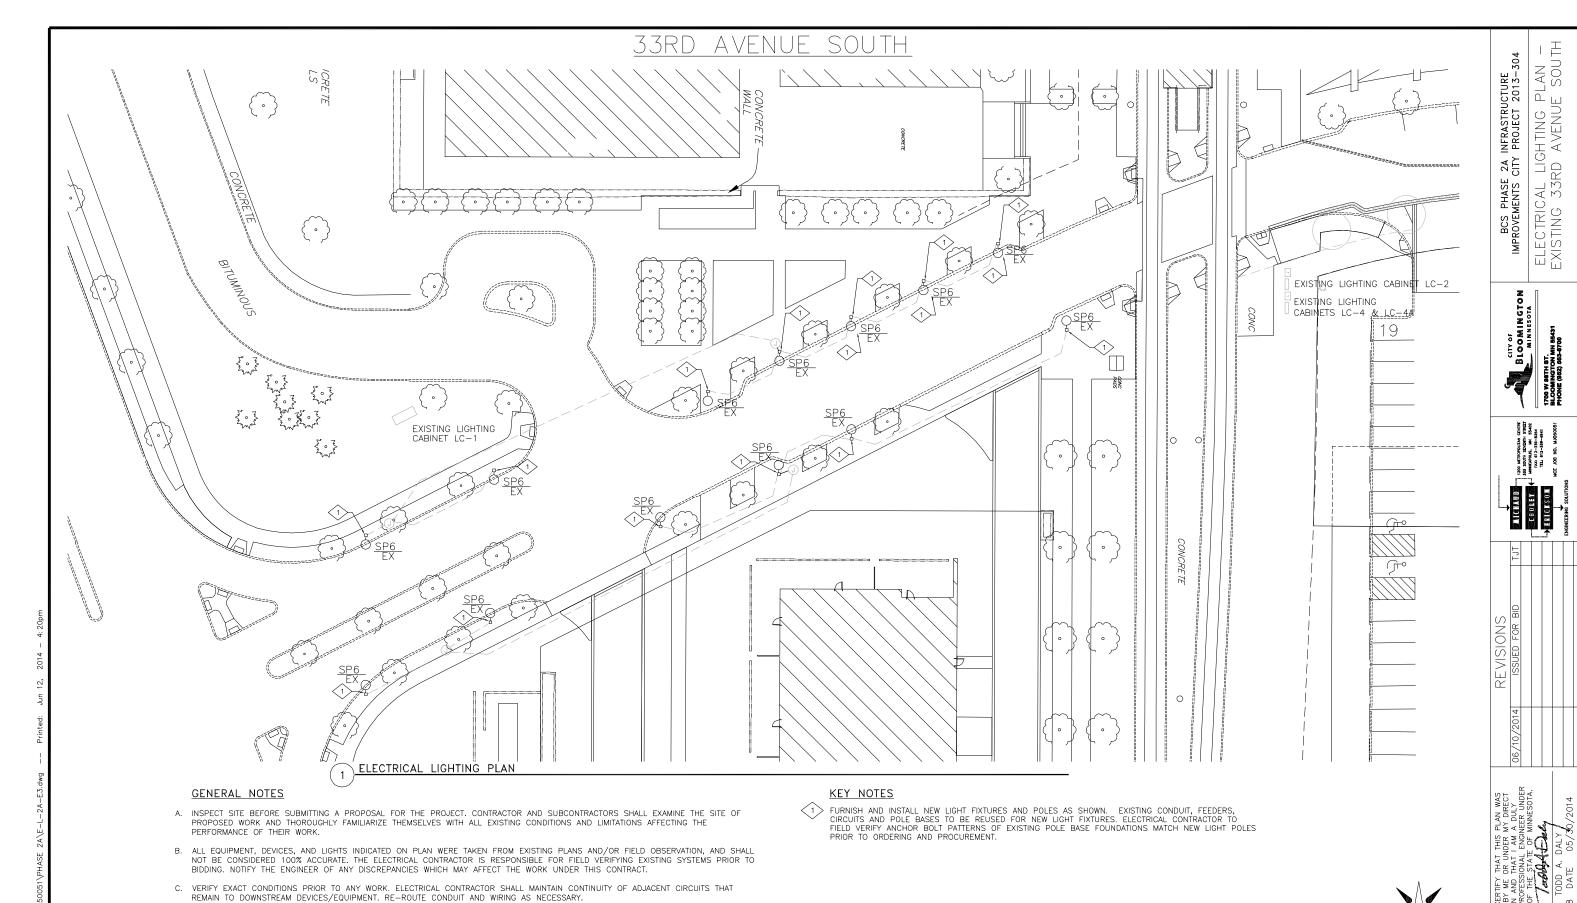


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DRAWN: BER CHECKED: JAK APPROVED: MJP

SHEET: E3 OF 83

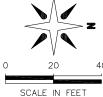

- A. REFER TO MNDOT STANDARD SPECIFICATIONS FOR CONSTRUCTION 2014 EDITION.
- B. ELECTRICAL CONTRACTOR TO COORDINATE ALL ELECTRICAL SITE WORK WITH CIVIL, ARCHITECTURAL, AND MECHANICAL DRAWINGS, AS WELL AS EXISTING SITE CONDITIONS, PRIOR TO INSTALLATION.
- C. ALL WIRING OF STREET LIGHTING BETWEEN POLES SHALL BE PLACED IN CONDUITS WITHIN THE BOULEVARD AREA ADJACENT TO THE STREET. CONDUITS LOCATED UNDER NON-DRIVEABLE AREAS SHALL BE 2 INCH RSC. ALL STREET LIGHTING CONDUITS LOCATED UNDER ROADWAYS AND/OR DRIVEWAYS SHALL BE 3 INCH RSC THAT EXTENDS THE LENGTH OF THE STREET OR DRIVEWAY CROSSING.
- D. NO LIGHTING CONDUITS SHALL BE PLACED IN IRRIGATION LINES, SUCH AS SPRINKLER SYSTEM LINES, ETC.
- E. CONDUIT AND HAND HOLES TO BE INSTALLED IN ROADWAY
- F. FURNISH AND INSTALL HAND HOLES AS REQUIRED FOR CONDUIT ROUTING TO LIGHT FIXTURES.
- 1) REFER TO DETAIL 2 ON SHEET E10 FOR POLE BASE DETAILS.
- 2 EXISTING CONDUIT AND FEEDER TO REMAIN, FURNISH AND INSTALL PROTECTION DURING CONSTRUCTION.
- FURNISH AND INSTALL ROADWAY LIGHTING SERVICE CABINET. REFER TO SHEET E11 FOR ROADWAY LIGHTING SERVICE CABINET DESCRIPTION.
- CARLON (E989RRR SERIES OR APPROVED EQUAL) DIRECT BURIAL JUNCTION BOX TYPICAL.
- 5> CIRCUIT SITE LIGHTING TO LIGHTING SERVICE CABINET, TO 20A/2P CIRCUIT BREAKER. REFER TO POWER PLAN AND PANELBOARD SCHEDULE.
- 6 COORDINATE LIGHT FIXTURE LOCATION WITH TEMPORARY DRIVE, MAKE PROVISIONS FOR FUTURE INSTALLATION OF LIGHT FIXTURE.
- > EXISTING CONDUIT AND FEEDER FOR HEALTHPARTNERS PARKING LOT LIGHTING TO REMAIN, COORDINATE WITH CIVIL ENGINEER AND ARCHITECT FOR EXACT LOCATION.
- NEW HAND HOLE. FURNISH AND INSTALL A QUAZITE EXTRA HEAVY DUTY ANSI TIER 22/SCTE 77 RATED BOX AND COVER PER CITY STANDARDS.

REVISIONS ISSUED FOR BID AT THIS PLA UNDER MY AT I AM A D AL ENGINEER ATE OF MINI

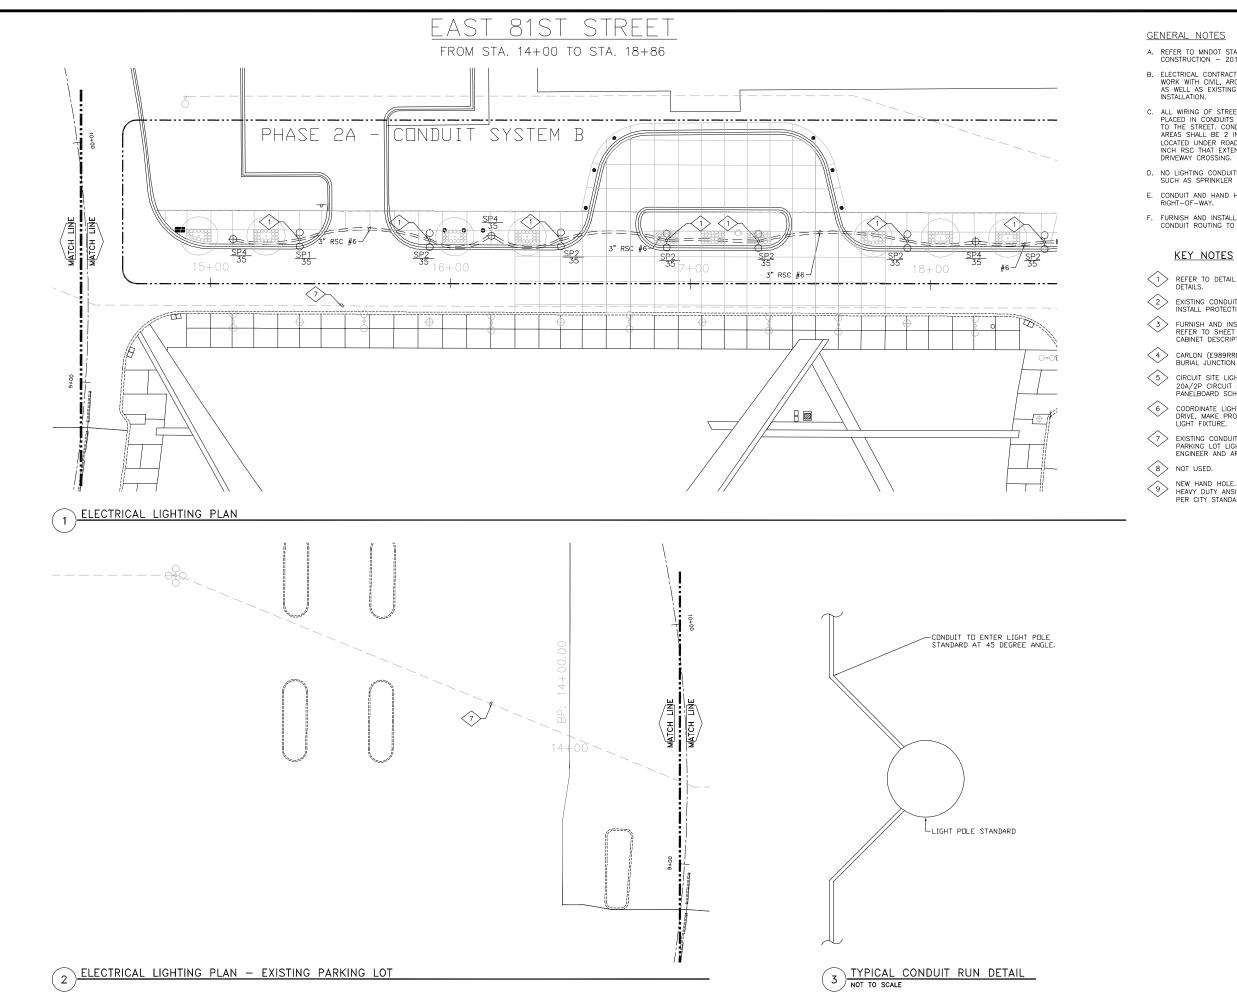L LIGHTING PLAN 81ST STREET 7a. 14+00 TO STA. 18+86

ELECTRICAL EAST 8

1700 W 88TH ST. BLOOMINGTON MN 55431 PHONE (852) 563-8700

1200 METROPOLTAN CENTRE 333 SOUTH SEVENTH STREET MINNECAPOLIS, MN 55402 FAX: 612-339-8354 TEL 612-339-4941

2A INFRASTRUCTURE CITY PROJECT 2013-

BCS PHASE IMPROVEMENTS C

BLOOMINGTON

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SCALE IN FEET

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SHEET: E4 OF 83


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- E. CONDUIT AND HAND HOLES TO BE INSTALLED IN ROADWAY RIGHT-OF-WAY.
- F. FURNISH AND INSTALL HAND HOLES AS REQUIRED FOR CONDUIT ROUTING TO LIGHT FIXTURES.


KEY NOTES

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- 7 EXISTING CONDUIT AND FEEDER FOR HEALTHPARTNERS PARKING LOT LIGHTING TO REMAIN, COORDINATE WITH CIVIL ENGINEER AND ARCHITECT FOR EXACT LOCATION.
- 8 NOT USED.
- 9 NEW HAND HOLE. FURNISH AND INSTALL A QUAZITE EXTRA HEAVY DUTY ANSI TIER 22/SCTE 77 RATED BOX AND COVER PER CITY STANDARDS.

33RD AVE SOUTH

FROM STA. 5+18 TO STA. 9+50

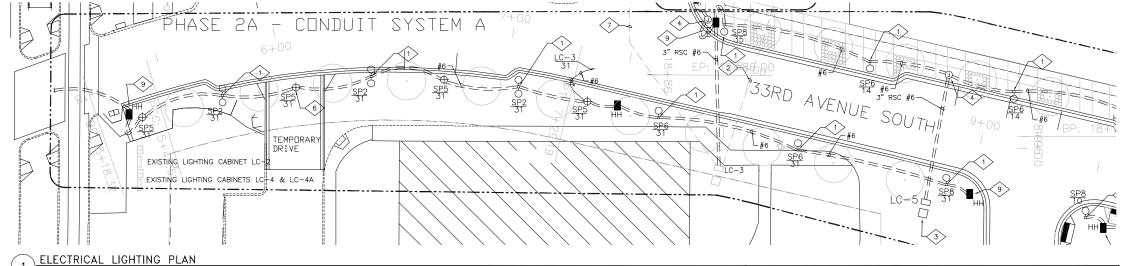

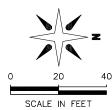

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LIGHTING PLAN AVE SOUTH 3. 5+18 to sta. 9+50

TRICAL 33RD FROM STA.

ELE

1700 W 88TH 8T. BLOOMINGTON MN 55431 PHONE (862) 663-8700

2A INFRASTRUCTURE CITY PROJECT 2013—.

BCS PHASE IMPROVEMENTS C

BLOOMINGTON MINNESOTA

1200 METROPOLTAN CENTRE 333 SOUTH SEVENTH STREET MINNECAPOLIS, MN 55402 FAX: 612-339-8354 TEL 612-339-4941


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33RD AVENUE SOUTH

FROM STA. 9+50 TO STA. 13+84



- 1 REFER TO DETAIL 2 ON SHEET E10 FOR POLE BASE DETAILS.
- 2 EXISTING CONDUIT AND FEEDER TO REMAIN, FURNISH AND INSTALL PROTECTION DURING CONSTRUCTION.
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1200 METROPOLITAN CENTRE 333 SOUTH SEVENTH STREET MINNEGAPOLIS, MN 55402 FAX: 612-339-8354 TEL: 612-339-4941

2A INFRASTRUCTURE CITY PROJECT 2013-304

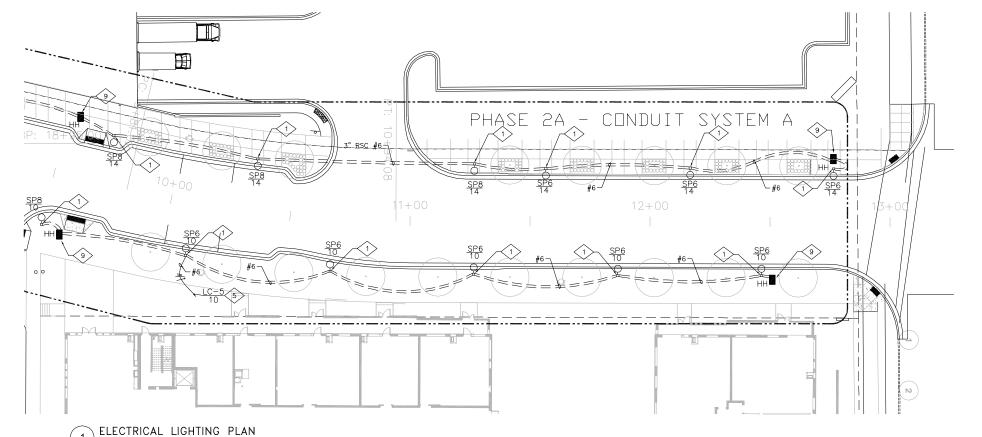BCS PHASE IMPROVEMENTS C

BLOOMINGTON MINNESOTA

LIGHTING PLAN AVE SOUTH 9+50 to 574, 13+84

TRICAL 33RD FROM STA.


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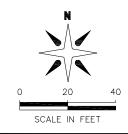
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E6 OF 83



- D. SUPPORTS FOR CONDUIT SHALL BE UL LISTED FOR THE PURPOSE AND SHALL BE INSTALLED AS REQUIRED BY THE NEC. REFER TO STRUCTURAL PLANS AND DETAILS FOR FASTENING REQUIREMENTS WHERE ATTACHING TO PARKING RAMP STRUCTURE.
- E. ALL INSTALLATION MATERIALS AND METHODS SHALL CONFORM TO THE REQUIREMENTS OF THE CURRENT NATIONAL ELECTRICAL CODE (NFPA 70) AND ALL APPLICABLE LOCAL, STATE, AND NATIONAL CODES.
- F. REFER TO THE ARCHITECTURAL DETAILS AND ELEVATION DRAWINGS FOR COORDINATION OF ALL ELECTRICAL DEVICES.
- G. REFER TO MNDOT STANDARD SPECIFICATIONS FOR CONSTRUCTION $-2014\ \mbox{EDITION}.$
- H. ELECTRICAL CONTRACTOR TO COORDINATE ALL ELECTRICAL SITE WORK WITH CIVIL, ARCHITECTURAL, AND MECHANICAL DRAWINGS, AS WELL AS EXISTING SITE CONDITIONS, PRIOR TO INSTALLATION.
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- J. NO POWER/SYSTEMS CONDUITS SHALL BE PLACED IN IRRIGATION LINES, SUCH AS SPRINKLER SYSTEM LINES, ETC.



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THE STATE OF MINNESOTA.
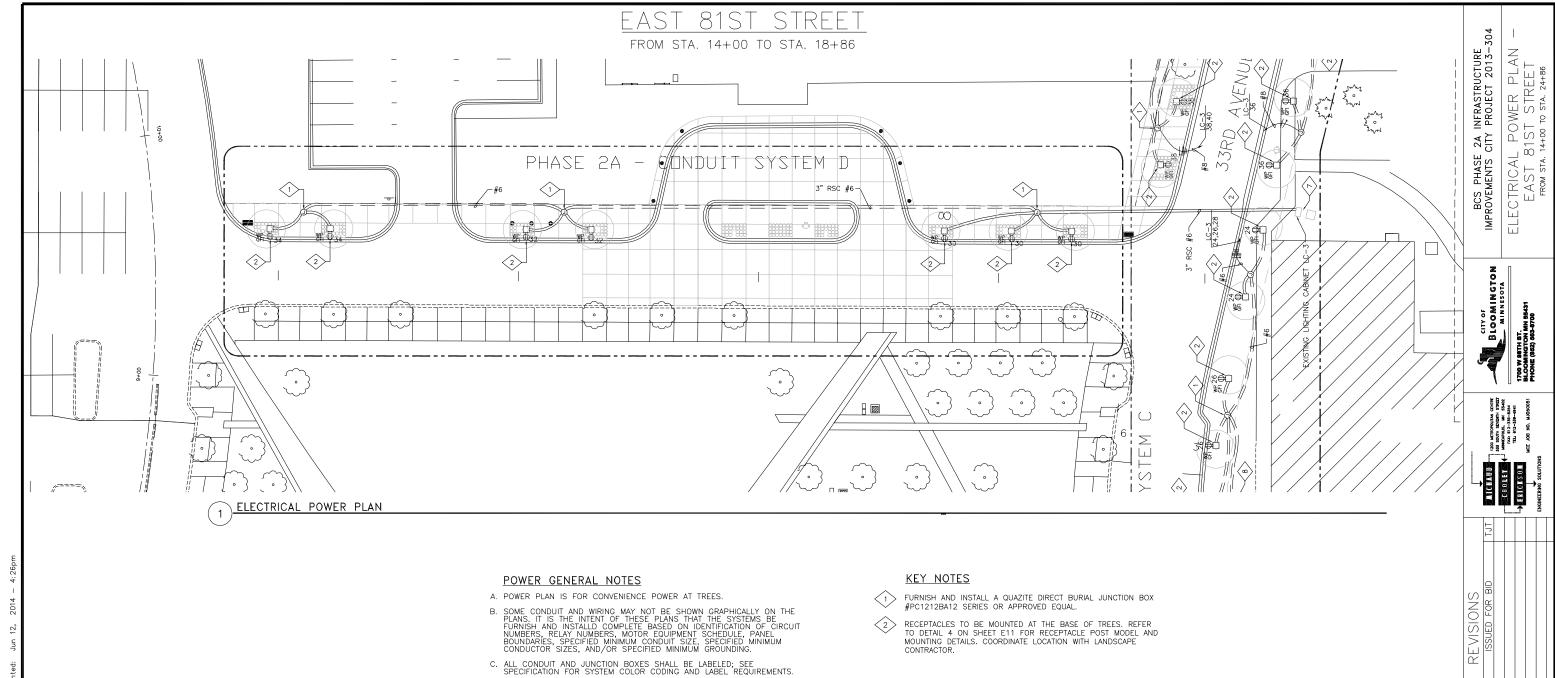
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CHECKED: JAK APPROVED: MJP

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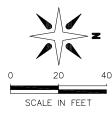
E7 OF 83

POWER GENERAL NOTES

- A. POWER PLAN IS FOR CONVENIENCE POWER AT TREES.
- B. SOME CONDUIT AND WIRING MAY NOT BE SHOWN GRAPHICALLY ON THE PLANS. IT IS THE INTENT OF THESE PLANS THAT THE SYSTEMS BE FURNISH AND INSTALLD COMPLETE BASED ON IDENTIFICATION OF CIRCUIT NUMBERS, RELAY NUMBERS, MOTOR EQUIPMENT SCHEDULE, PANEL BOUNDARIES, SPECIFIED MINIMUM CONDUIT SIZE, SPECIFIED MINIMUM CONDUCTOR SIZES, AND/OR SPECIFIED MINIMUM GROUNDING.
- C. ALL CONDUIT AND JUNCTION BOXES SHALL BE LABELED; SEE SPECIFICATION FOR SYSTEM COLOR CODING AND LABEL REQUIREMENTS.
- D. SUPPORTS FOR CONDUIT SHALL BE UL LISTED FOR THE PURPOSE AND SHALL BE INSTALLED AS REQUIRED BY THE NEC. REFER TO STRUCTURAL PLANS AND DETAILS FOR FASTENING REQUIREMENTS WHERE ATTACHING TO PARKING RAMP STRUCTURE.
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KEY NOTES


- FURNISH AND INSTALL A QUAZITE DIRECT BURIAL JUNCTION BOX #PC1212BA12 SERIES OR APPROVED EQUAL.
- 2 RECEPTACLES TO BE MOUNTED AT THE BASE OF TREES. REFER TO DETAIL 4 ON SHEET E11 FOR RECEPTACLE POST MODEL AND MOUNTING DETAILS. COORDINATE LOCATION WITH LANDSCAPE CONTRACTOR.
- FURNISH AND INSTALL NEW ROADWAY LIGHTING SERVICE ENCLOSURE. REFER TO SHEET E11 FOR ADDITIONAL INFORMATION.FURNISH AND INSTALL 2" CONDUIT WITH 3#3/0 & 1#6 GND FROM XCEL TRANSFORMER TO NEW ROADWAY LIGHTING SERVICE CABINET. COORDINATE EXACT LOCATION WITH UTILITY
- XCEL TO FURNISH AND INSTALL IN-LINE SPLICE KIT AND SPLICE INTO EXISTING 13.8 KVA XCEL FEEDERS TO FEED INTO ELECTRICAL ROADWAY LIGHTING SERVICE CABINET (FURNISH AND INSTALLD BY THE ELECTRICAL CONTRACTOR) AND XCEL FURNISH AND INSTALLD TRANSFORMER, COORDINATE WITH XCEL POWER.
- 5 FURNISH AND INSTALL A 4" EMPTY CONDUIT FOR XCEL USE, VERIFY EXACT SIZE AND LOCATION WITH XCEL.
- 6 RECEPTACLES TO BE MOUNTED BETWEEN TREES. REFER TO DETAIL 4 ON SHEET E11 FOR RECEPTACLE POST MODEL AND MOUNTING DETAILS. COORDINATE LOCATION WITH LANDSCAPE CONTRACTOR
- 7 FURNISH AND INSTALL (9) 20A/1P AND (2) 20A/2P CIRCUIT BREAKERS IN EXISTING LIGHTING SERVICE CABINET LC-3.
- B FURNISH AND INSTALL A DEDICATED 120V CIRCUIT FOR THE LAWN IRRIGATION EQUIPMENT CONTROLLER. COORDINATE EXACT LOCATION WITH LANDSCAPE CONTRACTOR. FURNISH AND INSTALL A 20A/1P CIRCUIT BREAKER IN NEAREST EXISTING PANEL. CONTRACTOR TO FIELD VERIFY EXACT PANEL LOCATION.
- 9 ELECTRICAL CONTRACTOR SHALL DISCONNECT AND RECONNECT EXISTING UTILITY AS REQUIRED FOR CONSTRUCTION, VERIFY EXACT REQUIREMENTS WITH UTILITY.



BCS PHASE 2A INFRASTRUCTURE IMPROVEMENTS CITY PROJECT 2013–3.

ELECTRICAL POWER PLAN 33RD AVE SOUTH FROM STA. 5+18 TO STA. 9+50

BLOOM IN GTON
BLOOM IN STATE
TOO WATH ST.
1700 W STH ST.
1700 W STH ST.

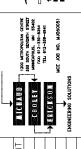


REVISIONS
06/10/2014 ISSUED FOR BID TJT

HEREBY CERTIFY THAT THIS PLAN WAS SEARED BY WE OR UNDER MY DIRECT PERFOISION AND THAT I AM A DULY ENSED PROFESSIONAL ENGINEER UNDER ILAWS OF THE STATE OF MINNESOTA.

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SHEET:

E8 OF 83

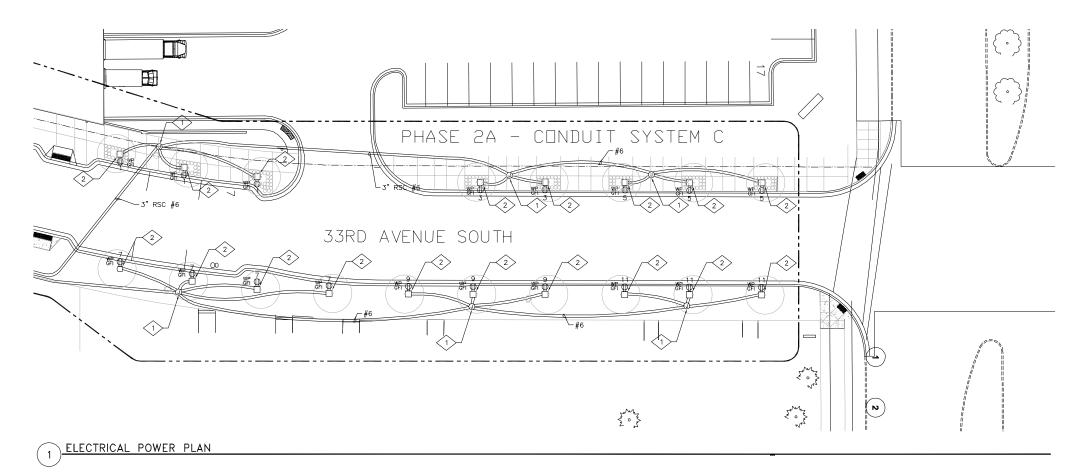


POWER GENERAL NOTES


- A. POWER PLAN IS FOR CONVENIENCE POWER AT TREES.
- SOME CONDUIT AND WIRING MAY NOT BE SHOWN GRAPHICALLY ON THE PLANS. IT IS THE INTENT OF THESE PLANS THAT THE SYSTEMS BE FURNISH AND INSTALLD COMPLETE BASED ON IDENTIFICATION OF CIRCUIT NUMBERS, RELAY NUMBERS, MOTOR EQUIPMENT SCHEDULE, PANEL BOUNDARIES, SPECIFIED MINIMUM CONDUIT SIZE, SPECIFIED MINIMUM CONDUCTOR SIZES, AND/OR SPECIFIED MINIMUM GROUNDING.
- C. ALL CONDUIT AND JUNCTION BOXES SHALL BE LABELED; SEE SPECIFICATION FOR SYSTEM COLOR CODING AND LABEL REQUIREMENTS.
- D. SUPPORTS FOR CONDUIT SHALL BE UL LISTED FOR THE PURPOSE AND SHALL BE INSTALLED AS REQUIRED BY THE NEC. REFER TO STRUCTURAL PLANS AND DETAILS FOR FASTENING REQUIREMENTS WHERE ATTACHING TO PARKING RAMP STRUCTURE.
- E. ALL INSTALLATION MATERIALS AND METHODS SHALL CONFORM TO THE REQUIREMENTS OF THE CURRENT NATIONAL ELECTRICAL CODE (NFPA 70) AND ALL APPLICABLE LOCAL, STATE, AND NATIONAL CODES.
- F. REFER TO THE ARCHITECTURAL DETAILS AND ELEVATION DRAWINGS FOR COORDINATION OF ALL ELECTRICAL DEVICES.
- G. REFER TO MNDOT STANDARD SPECIFICATIONS FOR CONSTRUCTION 2014 EDITION. H. ELECTRICAL CONTRACTOR TO COORDINATE ALL ELECTRICAL SITE WORK WITH CIVIL, ARCHITECTURAL, AND MECHANICAL DRAWINGS, AS WELL AS EXISTING SITE CONDITIONS, PRIOR TO INSTALLATION.
- ALL WIRING OF STREET LIGHTING BETWEEN POLES SHALL BE PLACED IN CONDUITS WITHIN THE BOULEVARD AREA ADJACENT TO THE STREET, TYPICALLY 6 INCHES BEHIND CURB. CONDUITS LOCATED UNDER NON-DRIVEABLE AREAS SHALL BE 2 INCH RSC. ALL STREET LIGHTING CONDUITS LOCATED UNDER ROADWAYS AND/OR DRIVEWAYS SHALL BE 3 INCH RSC THAT EXTENDS THE LENGTH OF THE STREET OR DRIVEWAY CROSSING.
- J. NO POWER/SYSTEMS CONDUITS SHALL BE PLACED IN IRRIGATION LINES, SUCH AS SPRINKLER SYSTEM LINES, ETC.

KEY NOTES

- FURNISH AND INSTALL A QUAZITE DIRECT BURIAL JUNCTION BOX #PC1212BA12 SERIES OR APPROVED EQUAL.
- RECEPTACLES TO BE MOUNTED AT THE BASE OF TREES. REFER TO DETAIL 4 ON SHEET E11 FOR RECEPTACLE POST MODEL AND MOUNTING DETAILS. COORDINATE LOCATION WITH LANDSCAPE CONTRACTOR.

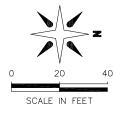

POWER PLAN AVE SOUTH 9+50 TO STA, 13+84 BCS PHASE 2A INFRASTRUCTURE IMPROVEMENTS CITY PROJECT 2013-TRICAL 33RD / FROM STA. 9 ELE

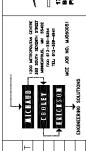

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SHEET:

E9 OF 83

LIGHT FIXTURE SCHEDULE

LTR TYPE	FIXTURE TYPE	SOURCE	MOUNTING	LAMPS	FEATURES	VOLTAGE & BALLAST	MANUFACTURER & CATALOG SERIES	NOTES	QUANTITY
SP1	TYPE SPECIAL 1-STREET AND PEDESTRIAN	МН	15' TAP. ALUM. POLE	(2) (1)100W ED-17 CLEAR AND (1)70PAR38	ALUMINUM ARM AND SHADE, ASYMMETRICAL RELFECTOR, BLACK FINISH, TWO FIXTURE HEADS, ONE AT 10' HEIGHT, THE OTHER AT 15', APPROX. 15' ROUND ALUMINUM POLE, INLINE FUSE	240V MAGNETIC	SELUX RITORNO CUST COMBO REFER TO SELUX QUOTE	1,3	1
SP2	TYPE SPECIAL 2-EXISTING/SALVAGED	МН	15' TAP. ALUM. POLE	(2) (1)100W ED-17 CLEAR AND (1)70PAR38	SAME AS TYPE SP1, SALVAGED AND RELOCATED	240V MAGNETIC	EXISTING-SALVAGED AND RELOCATED FROM PHASE 1	1,3	9
SP4	TYPE SPECIAL 4 PEDESTRIAN POLE-NO ARM	мн	10' ROUND ALUM, POLE	(1) 70PAR38/MH	ALUMINUM ARM AND SHADE, ASYMMETRICAL RELFECTOR, BLACK FINISH, DVERALL FIXTURE/POLE COMBO TO BE APPROX. 12', NO ARM, INLINE FUSE	240V MAGNETIC	SELUX RITORNO MINI REFER TO SELUX QUOTE NUMBER 110752	1,3	3
SP5	TYPE SPECIAL 5 EXISTING/SALVAGED	МН	10' ROUND ALUM. POLE	(1) 70PAR38/MH	SAME AS TYPE SP4, SALVAGED AND RELOCATED	240V MAGNETIC	EXISTING-SALVAGED AND RELOCATED FROM PHASE 1	1,3	4
SP6	TYPE SPECIAL 6 SELUX POLE- SHORT ARM	МН	16' TAPER ALUM. POLE	(1) 70WT/MED/M H	FORMED ALUMINUM HOUSING 19" DIAMETER, FLAT GLASS LENS, BLACK FINISH, 16" POLE, 5" STRAIGHT ALUMINUM POLE,S1 MOUNT-SINGLE 29" ARM, INLINE FUSE	240V MAGNETIC	SELUX ARC MINI WITH 16' POLE	1,2,3	26
SP8	TYPE SPECIAL 8 SELUX POLE- SHORT ARM	МН	16' TAPER ALUM. POLE	(1) 100WT/MED/ MH	SAME AS SP6, BUT 100WT LAMP	240V MAGNETIC	SELUX ARC MINI WITH 16' POLE	1,2,3	5

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ELECTRICAL DETAIL AND SCHEDULES

2A INFRASTRUCTURE CITY PROJECT 2013-

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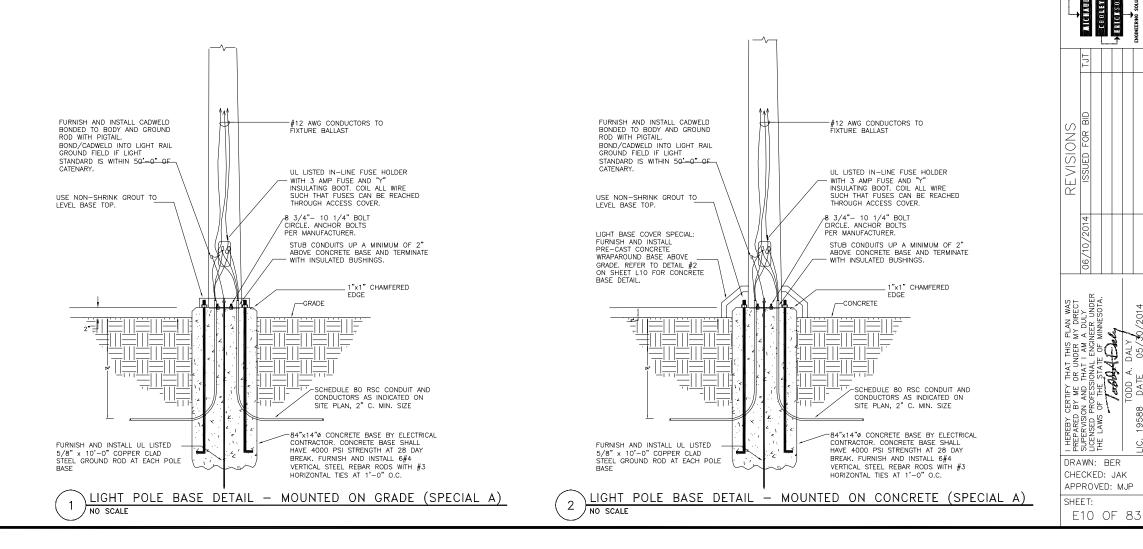
BLOOMINGTON MINNESOTA

1200 METROPOLITAN CENTRE 333 SOUTH SEVENTH STREET MINNECADLIS, MN 55402 FAX: 612-339-6354 TEL: 612-339-4941

1700 W 98TH 8T. BLOOMINGTON MN 55431 PHONE (862) 663-8700

NOTES:

- 1. FURNISH AND INSTALL COLORED PRECAST CONCRETE POLE BASE WHERE LIGHT POLES ARE
 MOUNTED ON CONCRETE, REFER TO LIGHT POLE BASE DETAIL MOUNTED ON CONCRETE (SPECIAL A)THIS SHEET.
 2. 13) TYPE SP6 TO BE MOUNTED ON EXISTING POLE BASES. VERIFY
 MOUNTING REQUIREMENTS AND ANCHOR BOLT CONFIGURATIONS, FURNISH AND INSTALL BOLT PATTERN ADAPTER.
 3. FURNISH AND INSTALL POLE BASE PER LIGHT POLE DETAIL MOUNTED ON GRADE (SPECIAL A) THIS SHEET.




PANELBOARD SCHEDULE

DESCRIPTION


SERVICE VOLTAGE

MOUNTING

120/240V

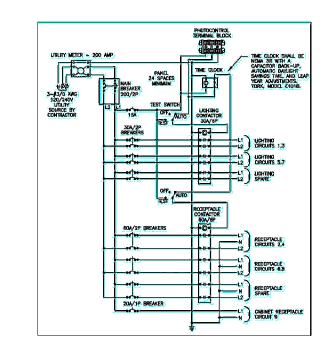


LIGHTING AND RECEPTACL CONTROL ENCLOSURE WIRING DIAGRAM

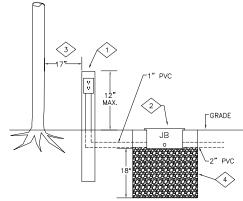

KEY NOTES

- GFI DUPLEX RECEPTACLE IN WEATHERPROOF POST, PEDOC POWER SOLUTIONS ONE GANG HINGE TOP, DIRECT BURIAL, NEMA 3R, BLACK FINISH.
- FURNISH AND INSTALL A QUAZITE DIRECT BURIAL JUNCTION BOX #PC1212BA12 SERIES OR APPROVED EQUAL. MOUNT JUNCTION BOX ABOVE WATER TABLE. LANDSCAPE CONTRACTOR TO BURY TOP OF BOX.
- 3 TREE FURNISH AND INSTALLD BY OTHERS. RECEPTACLE SHALL BE LOCATED APPROXIMATELY 17" FROM TREE. FIELD VERIFY EXACT LOCATION.
- FURNISH AND INSTALL 18" MINIMUM GRAVEL BELOW JUNCTION BOX.

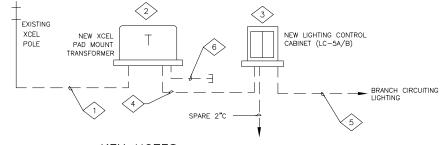

LC-5

= 20,000

PANEL DESIGNATION

FUTURE

FUTURE

SPARE

SPARE

SPARE

KAIC MIN

0.4 0.6 0.3

PHOTOCEL

LOCATION E. 80-1/2

ROADWAY LIGHTS

ROADWAY LIGHTS

100A

2P/3W

CKT BREAKER

No AMP POLE

10 20 2

16 -

18 20

22 20 2 24 - -26 20 2 28 - -

MCB

XCEL

20 -

BUS RATING

BREAKER CK


kVA

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BUS CONNECTION

KEY NOTES

- NEW XCEL UNDERGROUND 13.8KV FEEDER TO PAD MOUNTED TRANSFORMER. (NIC) VERIFY LOCATION OF UNDERGROUND FEEDER WITH XCEL AND GENERAL CONTRACTOR.
- 2 NEW 30KVA 13.8KVA TO 120/240 XCEL PAD MOUNT TRANSFORMER. FURNISH AND INSTALLD BY XCEL POWER. VERIFY SIZE/LOCATION WITH XCEL ENERGY.
- NEW 200 AMP 120/240, 1PH, 3 WIRE LIGHTING CONTROL CABINET FURNISH AND INSTALLD BY DIVISION 16, COORDINATE WITH XCEL POWER. CONTROL CABINET TO INCLUDE XCEL METER; BRANCH CIRCUIT BREAKERS; PHOTOCELLS: LIGHTINING ARRESTORS, TVSS. (REFER TO DETAIL SHEET 1/E14)
- 4 200 AMP 120/240, 1PH, 3 WIRE FEEDER BY DIVISION 16.
- 5 REFER TO LIGHTING PLAN AND POWER PLAN FOR CONDUIT SIZE AND ASSOCIATED WIRING.
- 6 FURNISH AND INSTALL A 4" EMPTY CONDUIT FROM FROM EXISTING XCEL PAD MOUNTED SWITCH. CONDUIT IS FOR FUTURE XCEL HIGH VOLTAGE FEEDER (LOOP)COORDINATE WITH XCEL POWER.

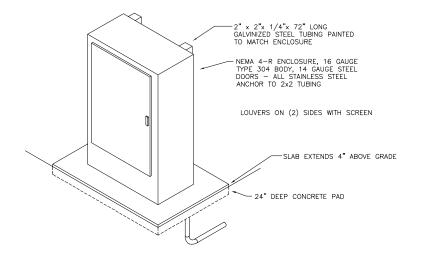

ENCLOSURE NOTES:

A. SEE DETAIL #1 ON SHEE E12 FOR ADDITIONAL INFORMATION.

RISER DIAGRAM NOT TO SCALE

2 LIGHTING AND RECEPTACL CONTROL ENCLOSURE

4 RECEPTACLE AT TREE DETAIL
NOT TO SCALE

REVISIONS ISSUED FOR BID

WIRING DIAGRAM AND SCHEDULES

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2A INFRASTRUCTURE CITY PROJECT 2013—.

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BLOOMII

1200 METROPOLITAN CENTRE 333 SOUTH SEVENTH STREET MINNECAPOLIS, MN 55-402 FAX: 612-339-8354 TEL 612-339-4941


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I HEREBY CERTIFY
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SUPERVISION AND T
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SHEET:

E11 OF 83



ELECTRICAL WIRING DIAGRAMS AND DETAILS

1700 W 88TH ST. BLOOMINGTON MN 55431 PHONE (862) 663-8700
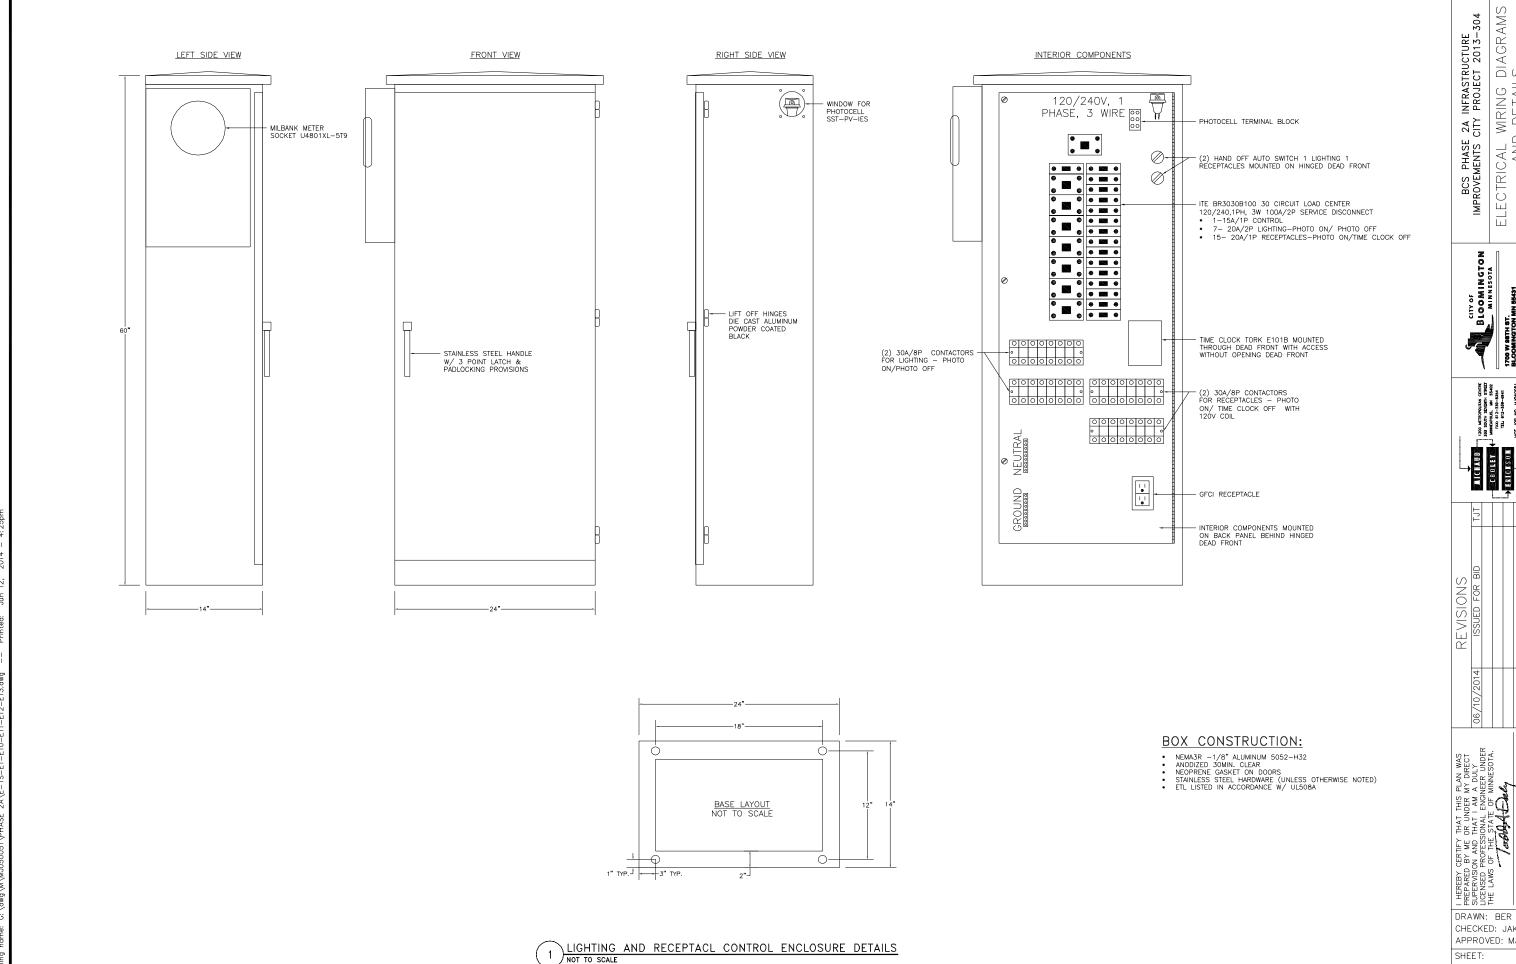
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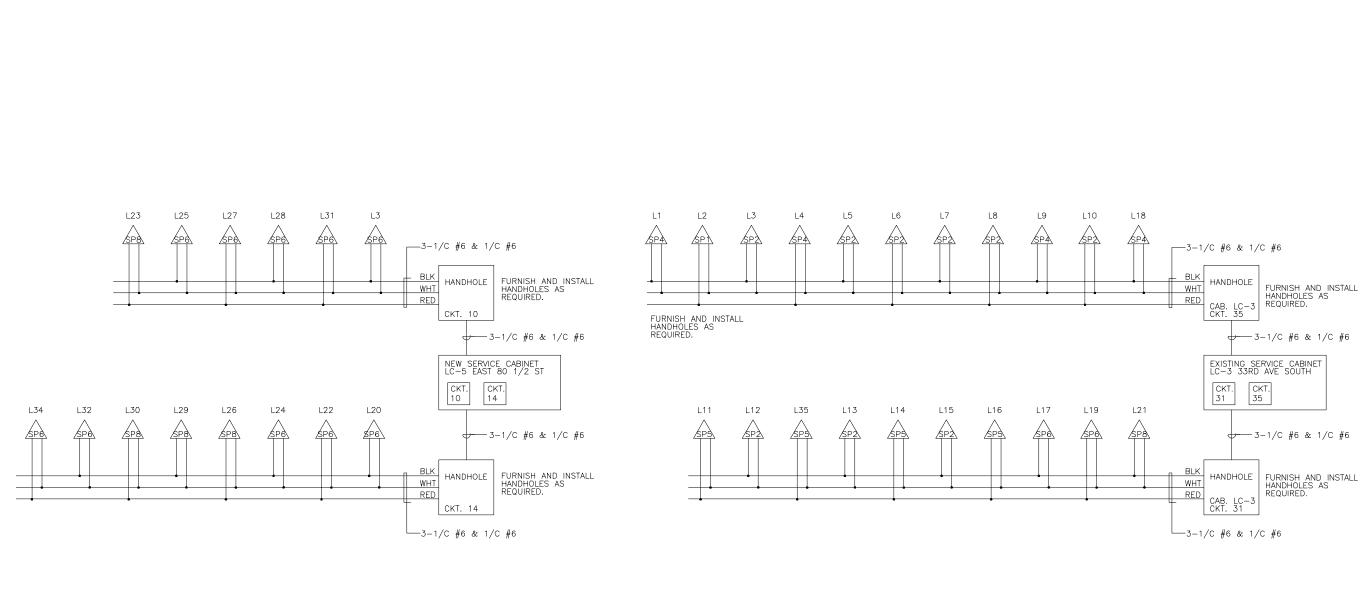
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ELECTRICAL WIRING DIAGRAMS

LEGEND

SPS STREET LIGHT IDENTIFIER

CIRCUIT BREAKER NUMBER

HANDHOLES/JUNCTION BOXES FOR SPLICING ARE NOT SHOWN, FURNISH AND INSTALL AS

REQUIRED, REFER TO PLANS FOR LOCATIONS.

DRAWN: BER CHECKED: JAK APPROVED: MJP SHEET:

DI HEREBY CERTIFY THAT THIS PLAN WAS PREABLED BY ME OR UNDER WY DIRECT SUPERVISION AND THAT I AM A DULY THE LOCKSED PROFESSIONAL ENGINEER UNDER THE STATE OF MINNESOTA.

BCS PHASE 2A INFRASTRUCTURE IMPROVEMENTS CITY PROJECT 2013-304

BLOOMINGTON MINNESOTA


1700 W 98TH ST. BLOOMINGTON WN 56431 PHONE (962) 969-8700

REVISIONS ISSUED FOR BID

06/10/2014


ELECTRICAL WIRING DIAGRAMS


E13 OF 83

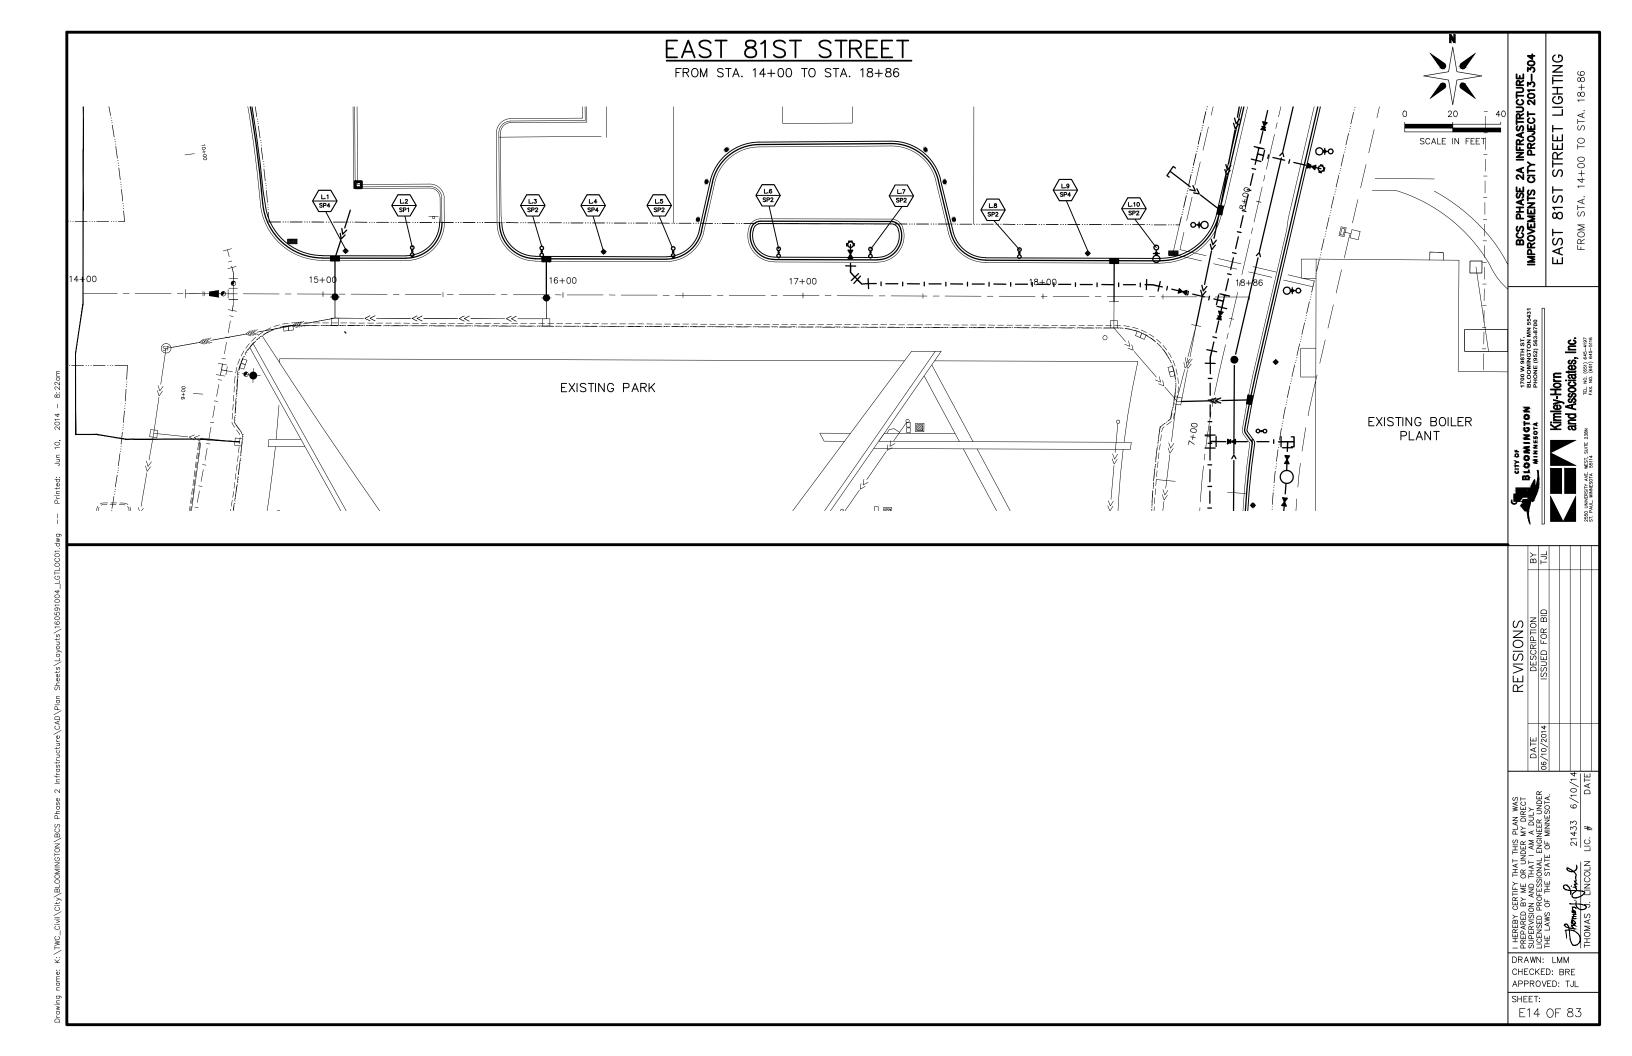




FROM STA. 5+18 TO STA. 13+84

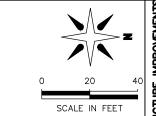

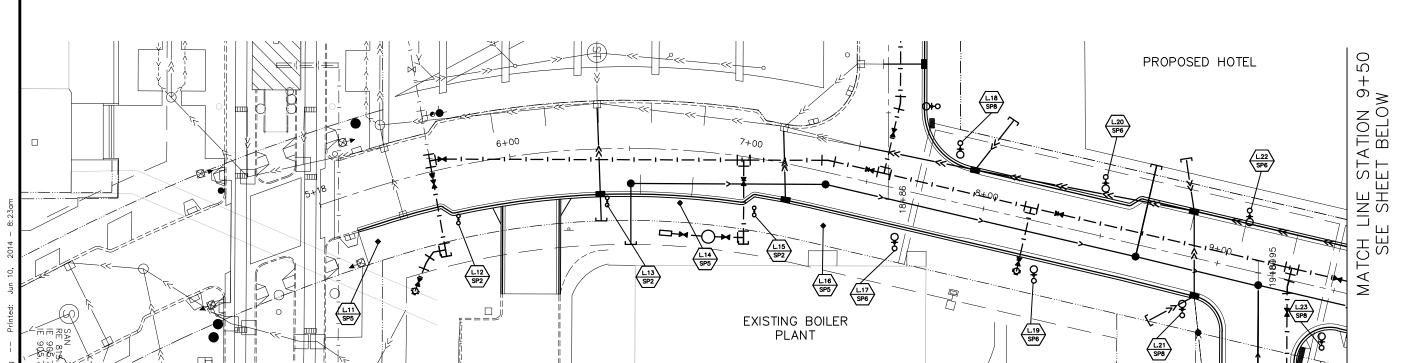

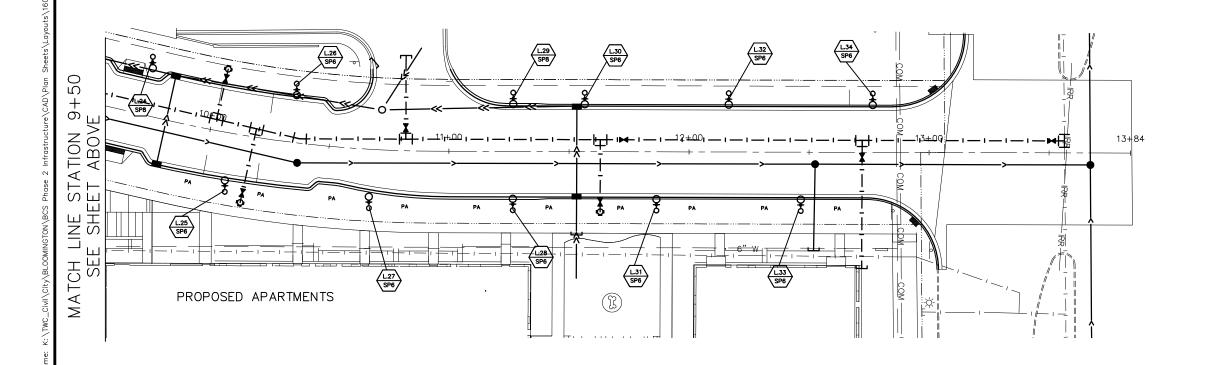

BCS PHASE 2A INFRASTRUCTURE IMPROVEMENTS CITY PROJECT 2013—304 33RD AVENUE SOUTH STREET LIGHTING
FROM STA. 5+18 TO_STA. 13+84

1700 W 98TH ST BLOOMINGTON MN 55431 PHONE (952) 563-8700 | Kimley-Horn | and Associates, Inc. BLOOMINGTON

REVISIONS
DESCRIPTION
ISSUED FOR BID 21433 6/10/14 LIC. # DATE

I HEREBY CERTIFY THAT THIS PLAN WAS PREPARED BY ME OR UNDER MY DIRECT SUPERVISION AND THAT I AM A DULY LICENSED PROFESSIONAL ENGINEER UNDER THE LAWS OF THE STATE OF MINNESOTA.

DRAWN: LMM CHECKED: BRE APPROVED: TJL

SHEET:

E15 OF 83

21433 6/10/14 LIC. # DATE THOMAS Y. KINCOLN

HEREBY CERTIFY THAT THIS PLAN WAS THAT THIS PLAN WAS THAT HEREBY CERTIFY THAT THIS PLAN WAS THAT HE AND DIFFER THE AND SHORT SHORT SHOW THAT I AM A DULY OF THE STATE OF MINNESOTA.

HE LAWS OF THE STATE OF MINNESOTA.

LIGHTING TABULATION								
ID	TYPE	ALIGNMENT	STATION	OFFSET	ELEVATION	NOTES		
L.1	SP-4	E. 81ST ST.	15+09.38	18.00' LT	817.50			
L.2	SP-1	E. 81ST ST.	15+37.14	18.00' LT	817.77			
L.3	SP-2	E. 81ST ST.	15+91.12	18.00' LT	818.37			
L.4	SP-4	E. 81ST ST.	16+16.88	18.00' LT	818.65			
L.5	SP-2	E. 81ST ST.	16+45.87	18.00' LT	818.97			
L.6	SP-2	E. 81ST ST.	16+89.81	18.00' LT	819.26			
L.7	SP-2	E. 81ST ST.	17+28.08	18.00' LT	819.26			
L.8	SP-2	E. 81ST ST.	17+90.14	18.00' LT	818.83			
L.9	SP-4	E. 81ST ST.	18+18.61	18.00' LT	818.60			
L.10	SP-2	E. 81ST ST.	18+47.19	18.00' LT	818.63			
L.11	SP-5	33RD AVE. S.	5+36.61	22.00' RT	816.89			
L.12	SP-2	33RD AVE. S.	5+73.41	22.00' RT	816.52			
L.13	SP-2	33RD AVE. S.	6+40.14	22.00' RT	817.19			
L.14	SP-5	33RD AVE. S.	6+72.52	22.00' RT	817.53			
L.15	SP-2	33RD AVE. S.	7+05.74	22.00' RT	818.04			
L.16	SP-5	33RD AVE. S.	7+36.60	22.00' RT	818.42			
L.17	SP-6	33RD AVE. S.	7+67.12	22.00' RT	818.92			
L.18	SP-8	33RD AVE. S.	7+84.98	22.00' LT	818.88			
L.19	SP-6	33RD AVE. S.	8+26.70	22.00' RT	817.38			
L.20	SP-6	33RD AVE. S.	8+47.20	22.00' LT	819.52			
L.21	SP-8	33RD AVE. S.	8+90.19	22.00' RT	819.80			
L.22	SP-6	33RD AVE. S.	9+08.78	22.00' LT	819.79			
L.23	SP-8	33RD AVE. S.	9+49.83	22.00' RT	819.96			
L.24	SP-8	33RD AVE. S.	9+70.37	22.00' LT	820.22			
L.25	SP-6	33RD AVE. S.	10+09.94	22.00' RT	820.46			
L.26	SP-6	33RD AVE. S.	10+33.75	22.00' LT	820.55			
L.27	SP-6	33RD AVE. S.	10+67.82	22.00' RT	820.85			
L.28	SP-6	33RD AVE. S.	11+26.65	22.00' RT	821.20			
L.29	SP-8	33RD AVE. S.	11+26.71	22.00' LT	821.21			
L.30	SP-6	33RD AVE. S.	11+56.53	22.00' LT	821.39			
L.31	SP-6	33RD AVE. S.	11+86.48	22.00' RT	821.57			
L.32	SP-6	33RD AVE. S.	12+16.49	22.00' LT	821.75			
L.33	SP-6	33RD AVE. S.	12+46.61	22.00' RT	821.86			
L.34	SP-6	33RD AVE. S.	12+76.48	22.00' LT	821.73			